
ČUNOVO WATER SPORTS CENTRE RESTORATION EAST CHANNEL DESIGN DRAWINGS ČUNOVO, SLOVAKIA JUNE, 2020

VICINITY MAP NTS

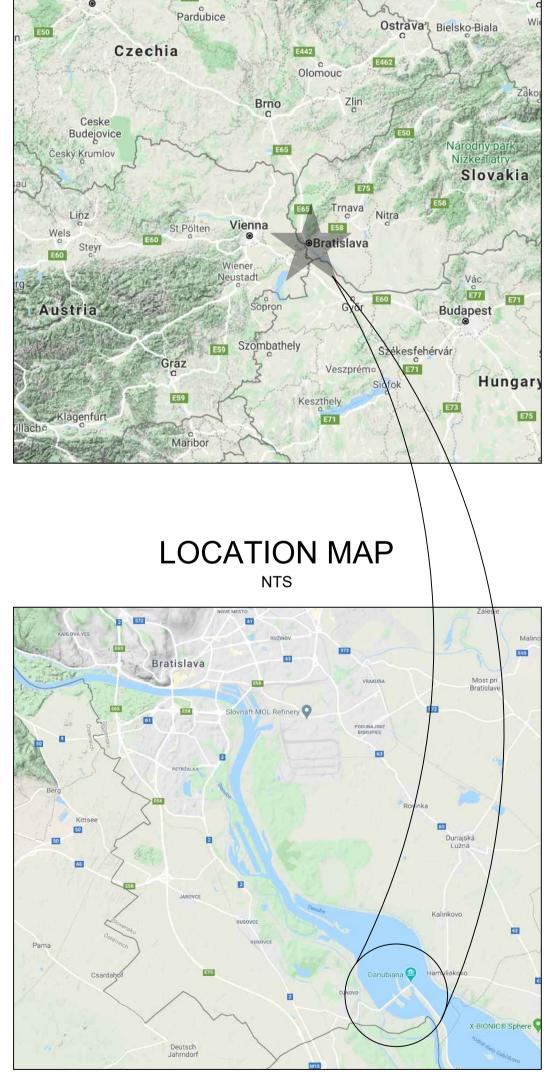

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	SY
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W	WEDGE
GR	GROYN
SR	SKILLS R
	START G
	SLAB WI
	EXISTING
	BRIDGE
	GRANDS
	STAIRS
	TERRACI
	PROPOS
	EXISTING
	CONCRE
	GATE MA
	GATE WI
	CUT
	FILL

CONTACT INFORMATION:

MR. SCOTT SHIPLEY, S2O PRINCIPAL PHONE: +13038193985

MBOLS AND ABBREVIATIONS					
LOCS OBSTACLES	1 2 3 4 5 6				
	W				
REPEATER					
GATE	ව ව ව ව ව ව ව ව ව ව ව ව ව ව ව ව ව ව ව				
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	1				

GENERAL NOTES:

- (I) FOR ANY QUESTIONS PLEASE CONTACT S20 REPRESENTATIVES. S20 REPRESENTATIVES MAY FIELD FIT ON SITE (2) WATER CONTROL: SEE DRAWINGS BY OTHERS
- (3) DEWATERING OPERATIONS: SEE DRAWINGS BY OTHERS
- (4) FOR CONCRETE THICKNESS SEE DRAWINGS BY OTHERS
- (5) FOR CONCRETE SPEC AND REINFORCEMENT SEE DRAWINGS BY OTHERS
- (6) FOR LANDSCAPE SEE DRAWINGS BY OTHERS
- (7) FOR RIVER BANKS SEE DRAWINGS BY OTHERS
- (8) A SAFETY PLAN AND SPILL KIT MUST BE REVIEWED PRIOR TO CONSTRUCTION AND KEPT ON SITE.
- (9) ALL PERMITS MUST BE IN CONTRACTORS POSSESSION ON SITE
- (10) CHANGE ORDERS MUST BE DONE IN WRITING AND APPROVED IN ADVANCE (II) ADDITIONAL HOURS FOR S20 ARE TO BE GIVEN ONLY WITH PRIOR APPROVAL
- (12) ALL ITEMS TO BE PROTECTED IN PLACE NEED TO BE SURROUNDED WITH TAPE PRIOR TO THE START OF CONSTRUCTION AND
- ΔPPROVED (13) ANY DAMAGE DONE TO EXISTING LANDSCAPE AND STRUCTURES DURING CONSTRUCTION IS TO BE REPLACED TO THE
- PRE-PROJECT CONDITION. (14) ANY SOIL LAID BARE SHOULD BE COVERED IMMEDIATELY IN COCONUT MAT AND SECURED.
- (15) PRIOR TO STARTING CONSTRUCTION ALL BMPS FOR EROSION CONTROL MUST BE IN PLACE.

Client:



S2O Design and Engineering

Scott Shipley, P.E. 318 Mcconnell Drive Lyons CO, 80540, USA +13038193985

SLOVAK CANOEING

Project Name: CUNOVO WATER SPORTS CENTRE RESTORATION

Status: 60% Design

Drawing Name SHEET INDEX

Revisions:

Drawn By: Riley Adams, Danial Mason Checked By: Scott Shipley

Date: 03/05/2020

Coordinate System: JTSK

Vertical Datum: Bpv

Stamp:

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Scale:



			05/14/2020 - 60% SCHEMATIC DESIGN				
Ç	SHEET						
	WW-0.0	COVER PAGE				+	
	WW-0.1	SHEET INDEX	\boxtimes				
	WW-0.2	EXISTING CONDITION SITE PLAN	\boxtimes				
	WW-0.3	PROPOSED CONDITION SITE PLAN	\boxtimes				
	WW-1.0	PROPOSED IMPROVEMENTS PLAN & PROFILE 1	\boxtimes				
	WW-2.0	PROPOSED CROSS-SECTIONS 1	\boxtimes				
	WW-2.1	PROPOSED CROSS SECTIONS 2	\boxtimes				
	WW-2.2	PROPOSED CROSS SECTIONS 3	\boxtimes				
	WW-2.3	PROPOSED CROSS SECTIONS 4	\boxtimes				
	WW-2.4	PROPOSED CROSS SECTIONS 5	\boxtimes				
	WW-2.5	PROPOSED CROSS SECTIONS 6	\boxtimes				
	WW-2.6	PROPOSED CROSS SECTIONS 7					
	WW-2.7	PROPOSED CROSS SECTIONS 8					
	WW-2.8	PROPOSED CROSS SECTIONS 9					
	WW-3.0	PROPOSED RAPID-BLOC LAYOUT OVERALL PLAN	\boxtimes				
	WW-3.1	SECTION 1 DETAILED PLAN	\boxtimes				
	WW-3.2	SECTION 2 DETAILED PLAN	\boxtimes				
	WW-3.3	SECTION 3 AND 4 DETAILED PLAN	\boxtimes				
	WW-3.4	SECTION 5 AND 6 DETAILED PLAN	\boxtimes				
	WW-3.5	SECTION 7 AND 8 DETAILED PLAN	\boxtimes				
	WW-4.0	TYPICAL DETAILS 1	\boxtimes				
	WW-4.1	TYPICAL DETAILS 2	\boxtimes				
	WW-4.2	TYPICAL DETAILS 3	\boxtimes				
	WW-5.0	PROPOSED CONSTRUCTION SEQUENCE					
	WW-5.1	PROPOSED CONSTRUCTION ACCESS					
	WW-6.0	ISOMETRIC VIEW (1)					
	WW-6.1	ISOMETRIC VIEW (2)	\boxtimes				
	WW-6.2	ISOMETRIC VIEW (3)	\boxtimes				
	WW-6.3	ISOMETRIC VIEW (4)	\boxtimes			\top	
	WW-6.4	ISOMETRIC VIEW (5)	\boxtimes				
	WW-6.5	ISOMETRIC VIEW (6)					
	WW-6.6	ISOMETRIC VIEW (7)					
	WW-6.7	ISOMETRIC VIEW (8)					
	KEY	,		 	 		

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CONTACT INFORMATION:

MR. SCOTT SHIPLEY, S2O PRINCIPAL PHONE: +13038193985



S2O Design and Engineering

Scott Shipley, P.E. 318 Mcconnell Drive Lyons CO, 80540, USA +13038193985

Client: SLOVAK CANOEING

Project Name: CUNOVO WATER SPORTS CENTRE RESTORATION

Status: 60% Design

Drawing Name: SHEET INDEX

Revisions:

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Drawn By: Riley Adams, Danial Mason Checked By: Scott Shipley

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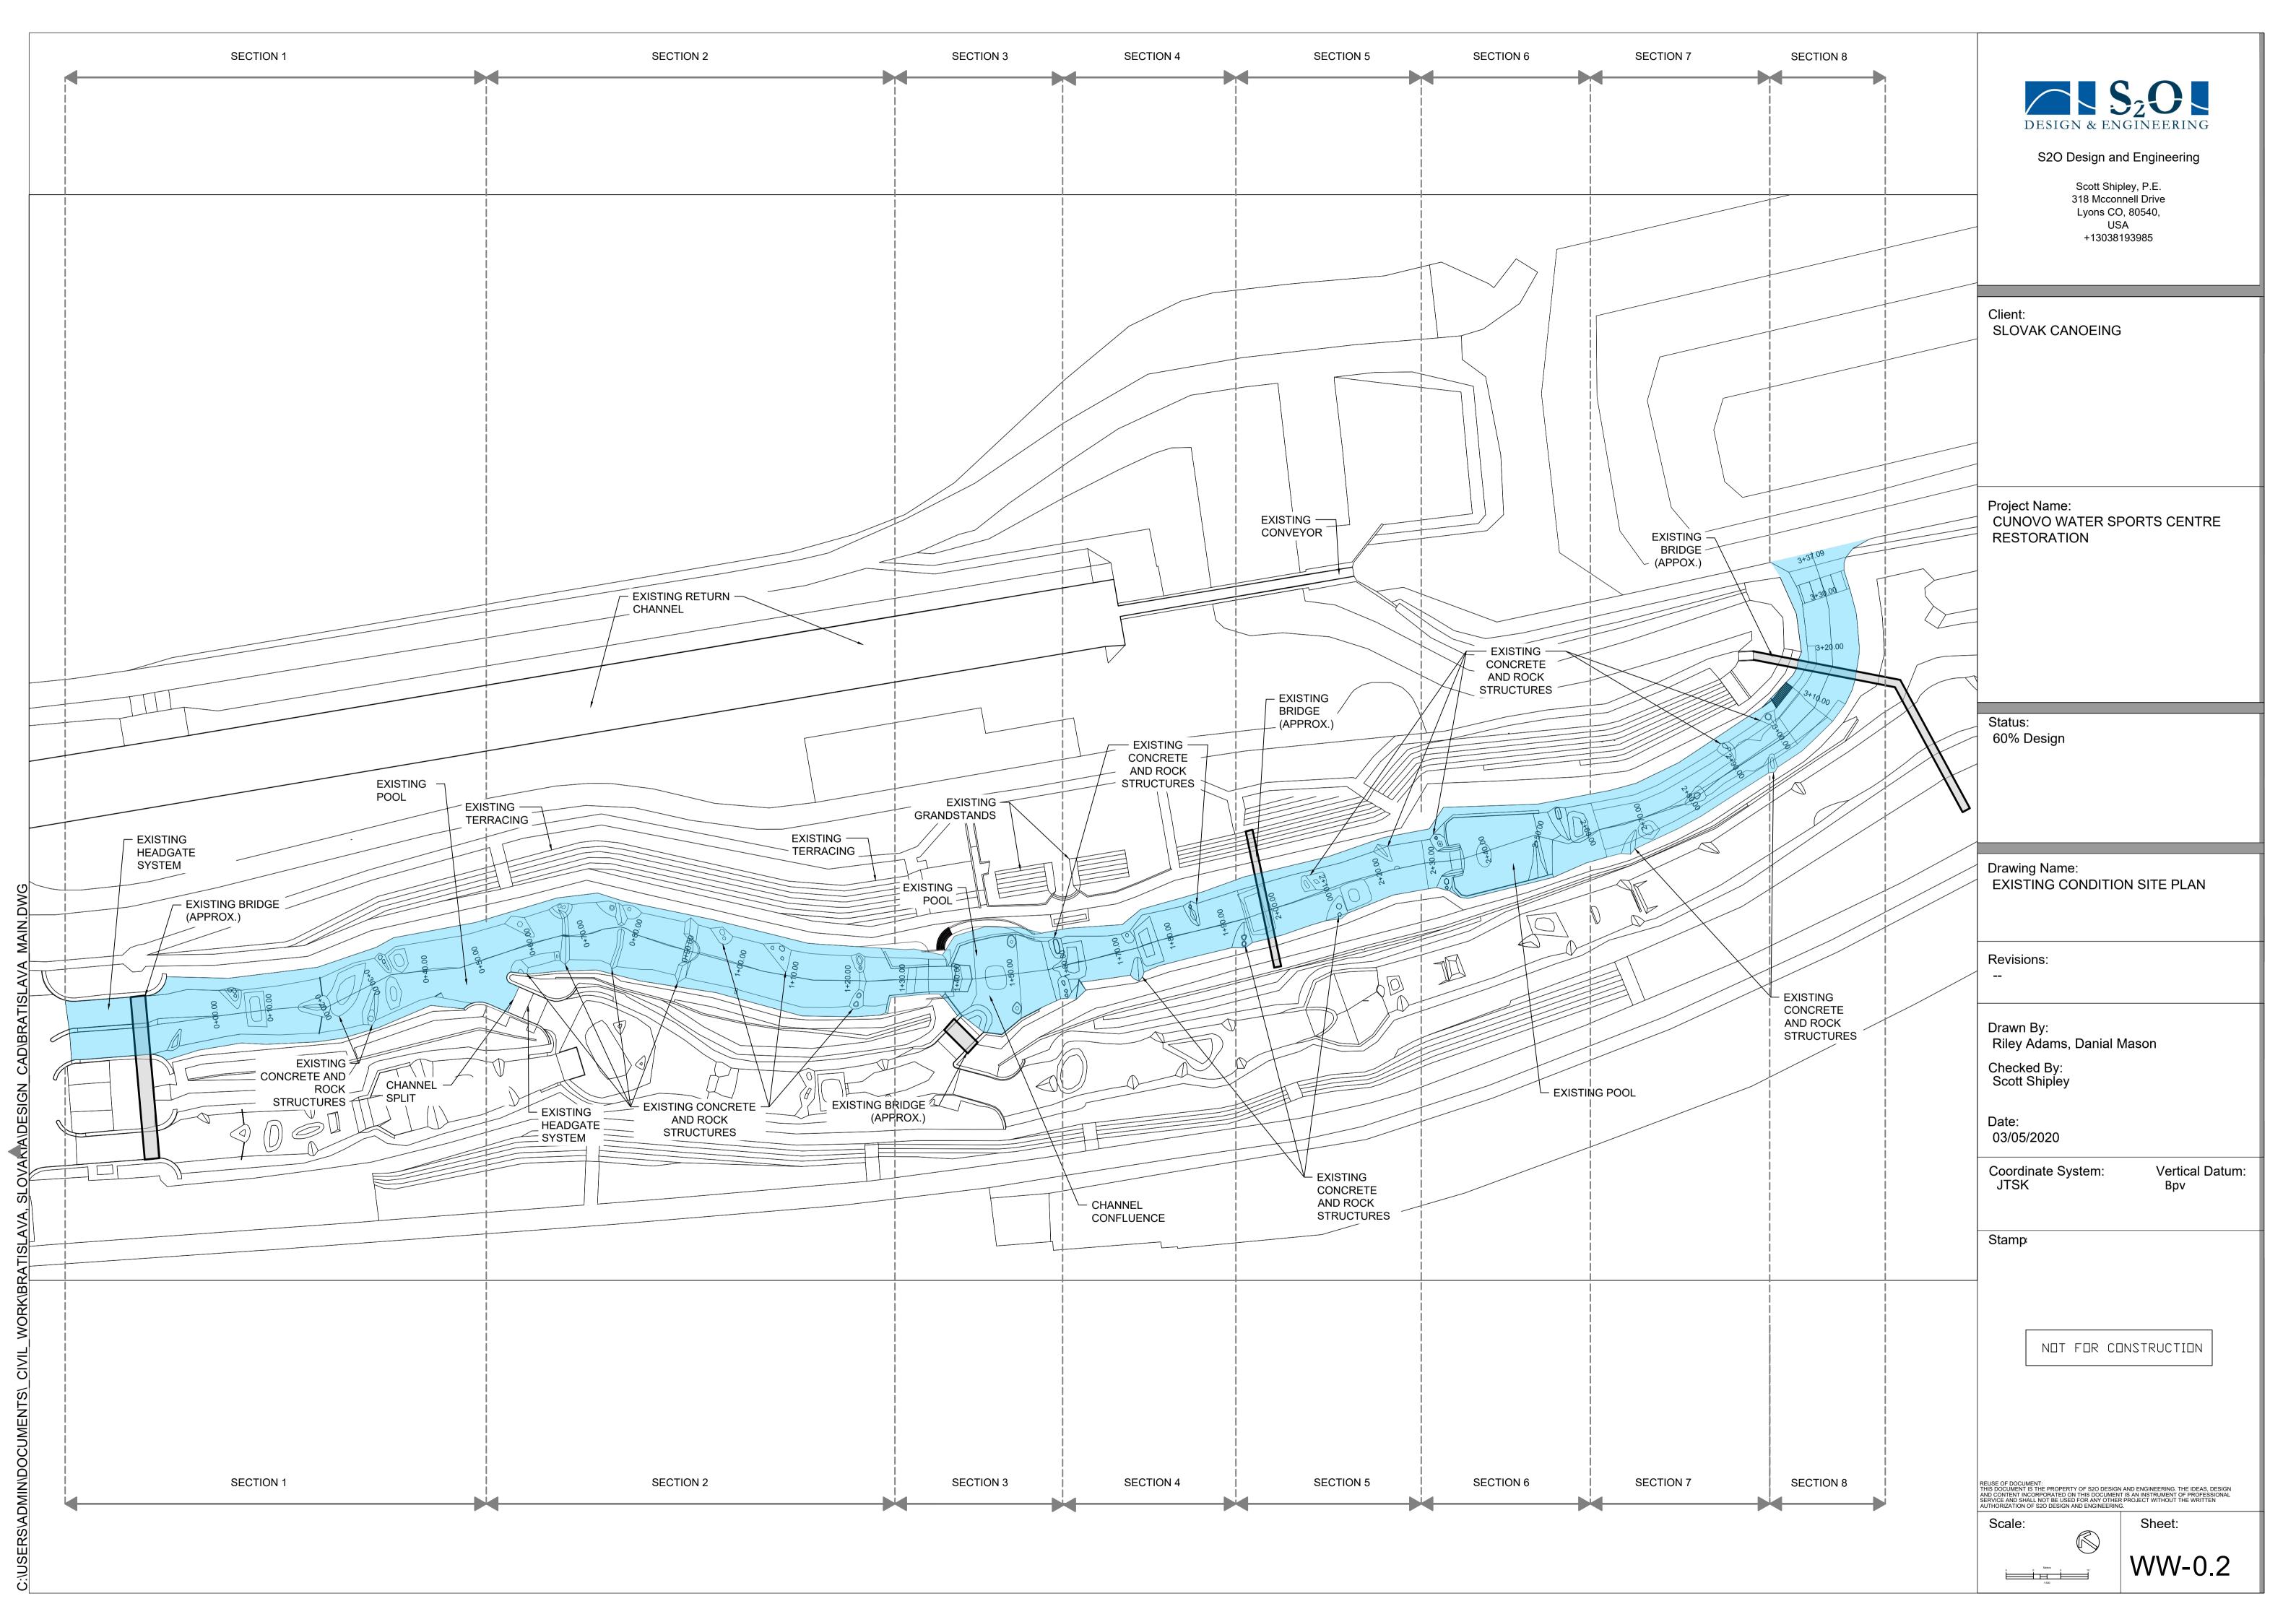
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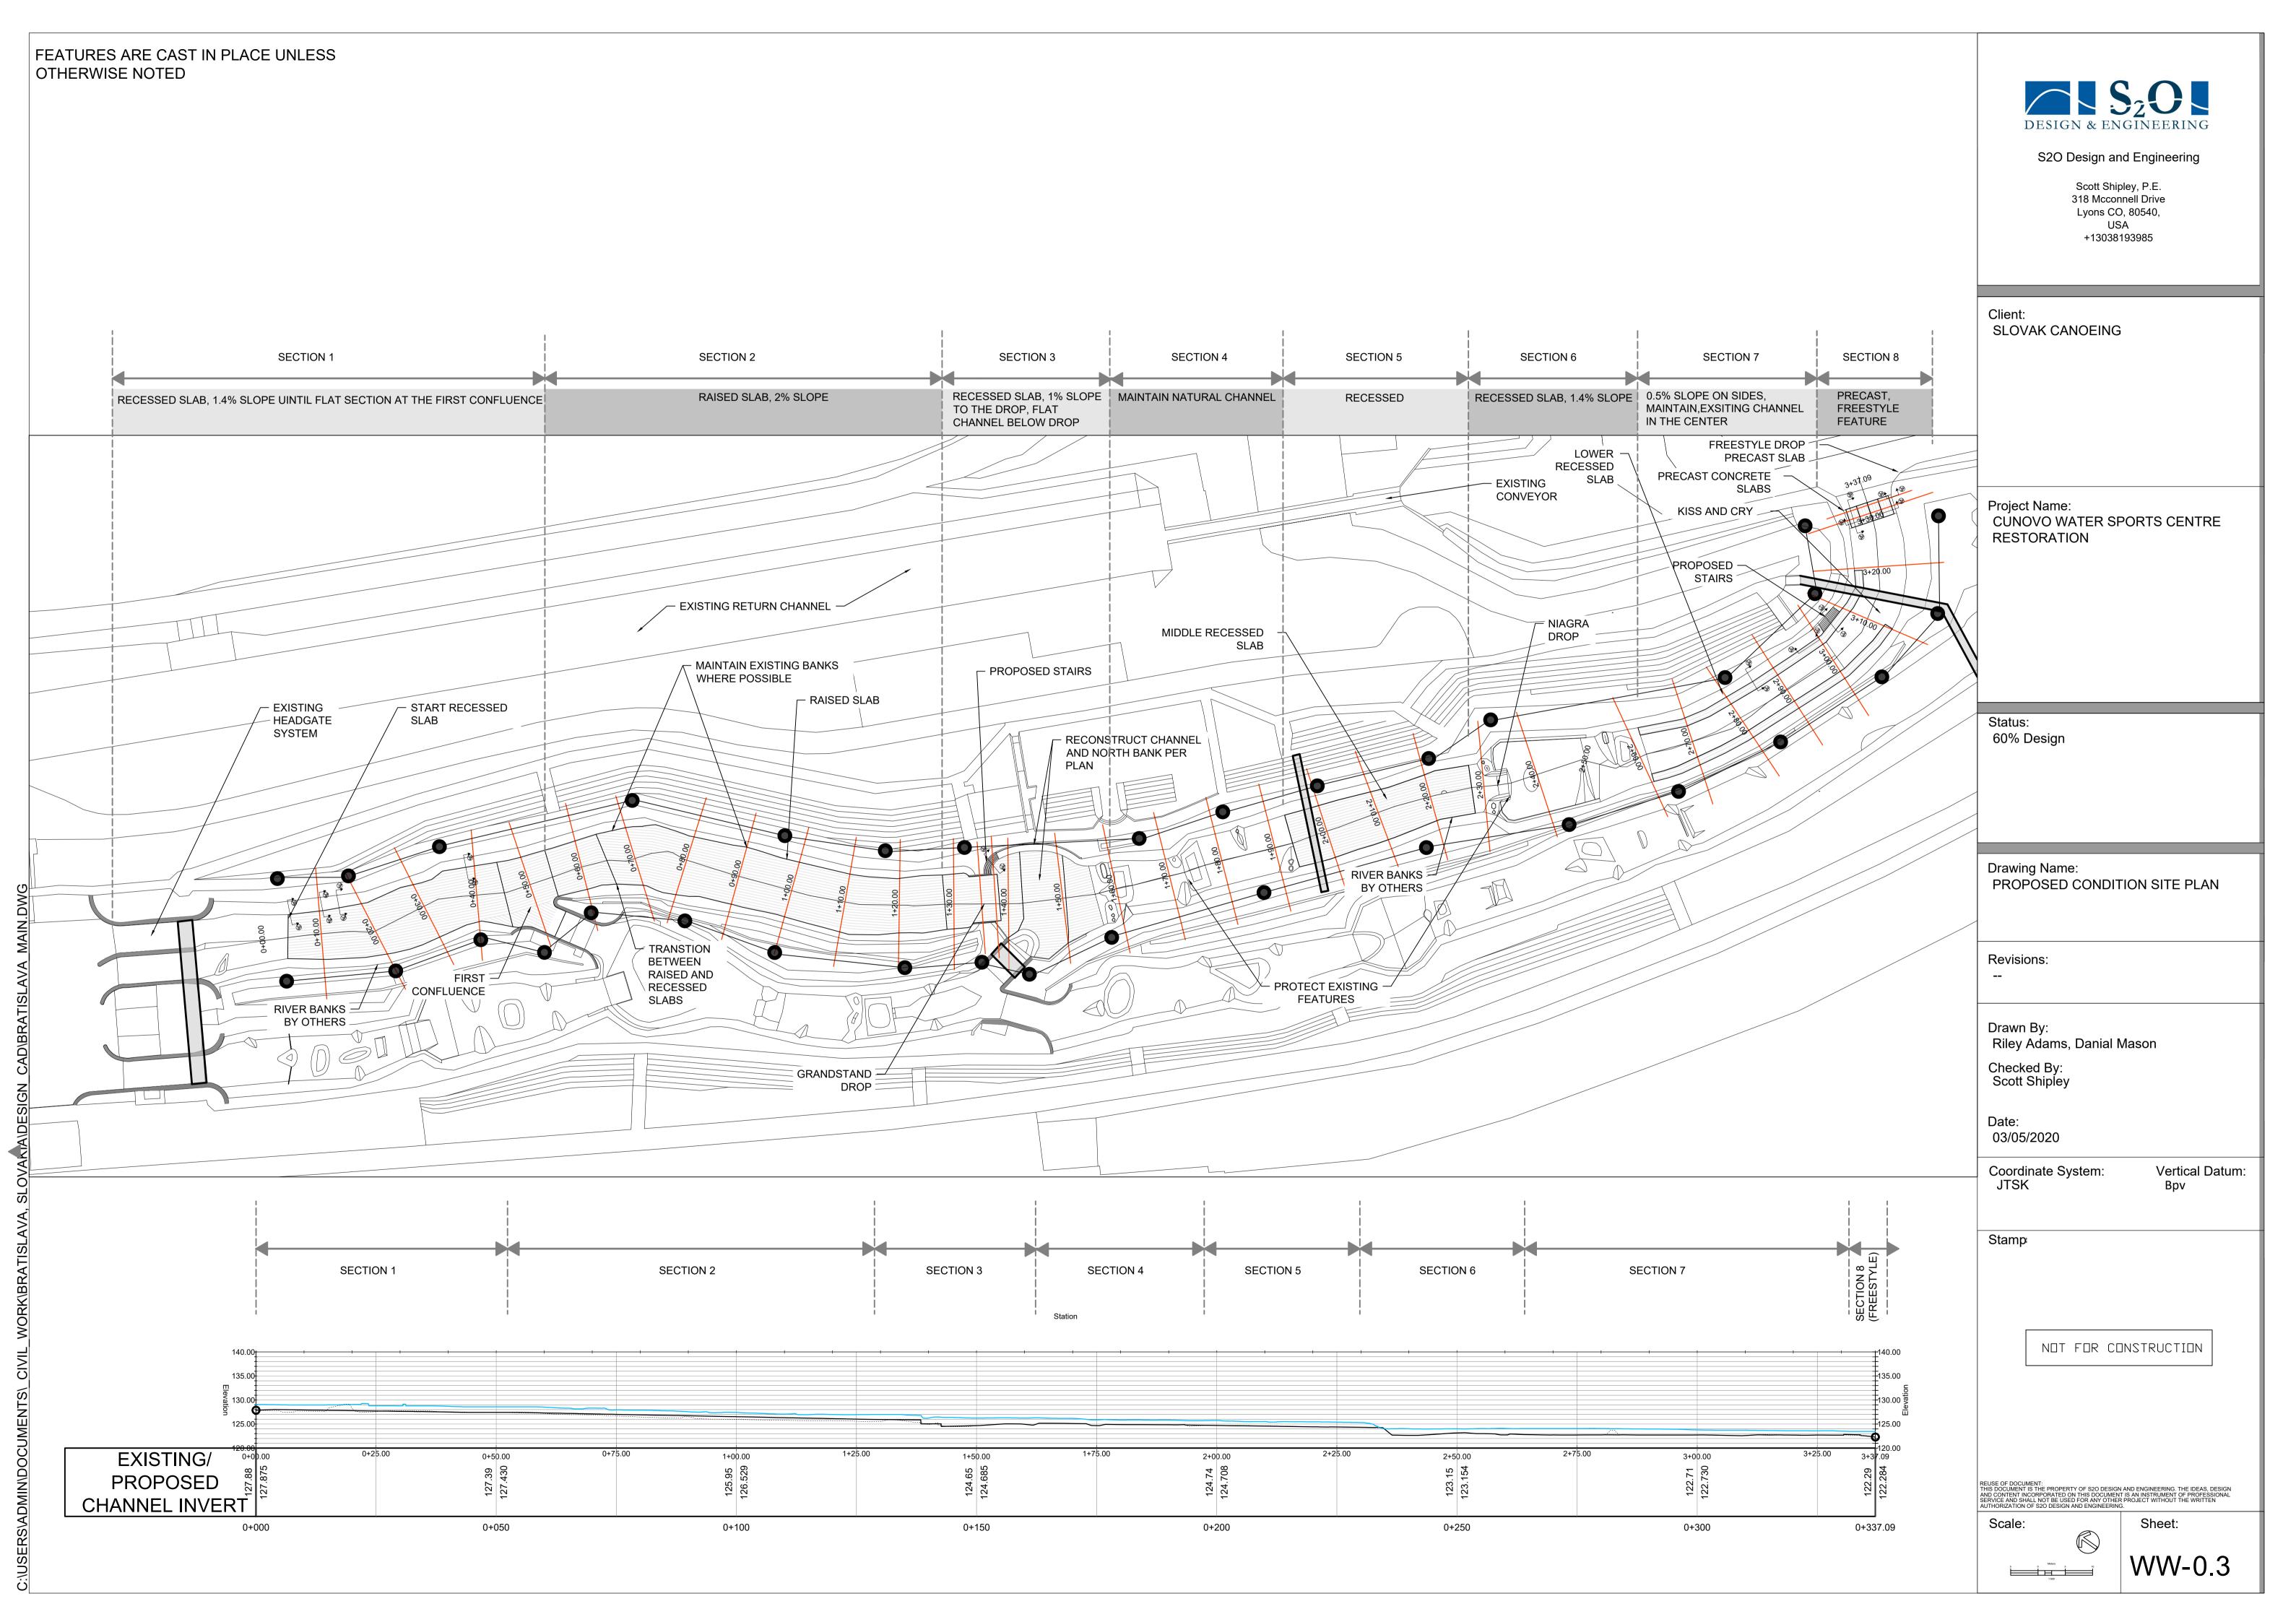
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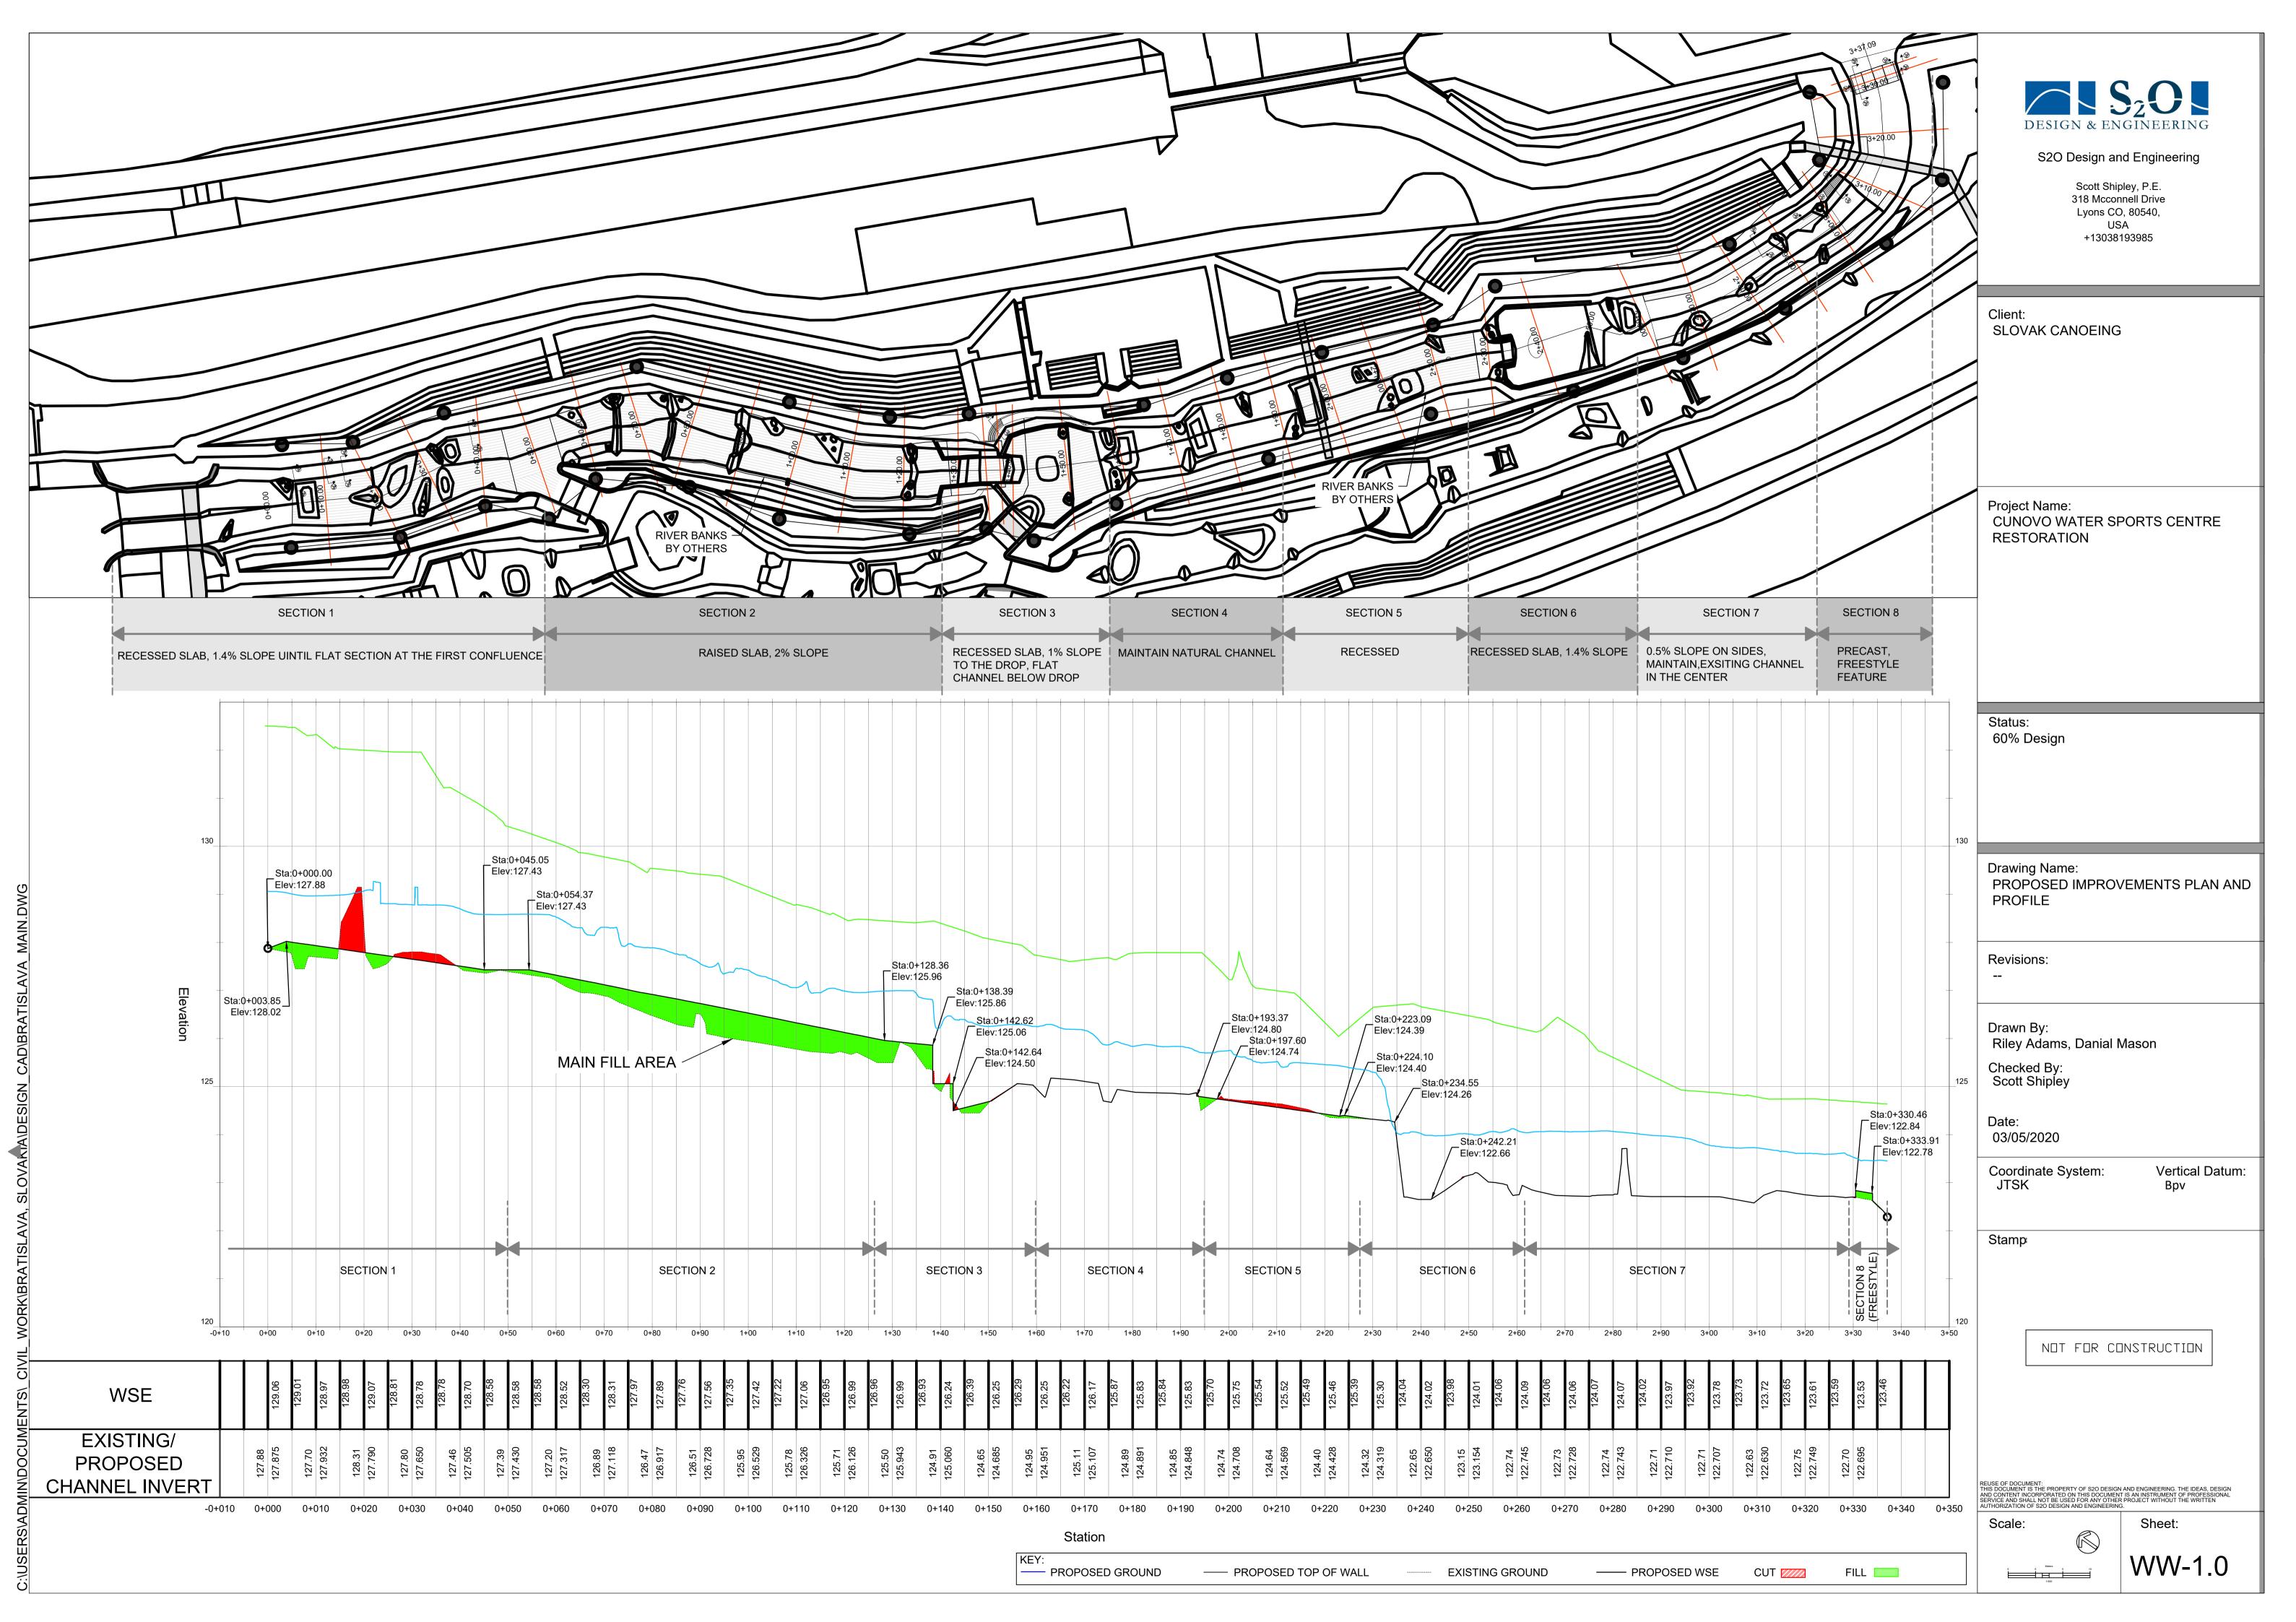
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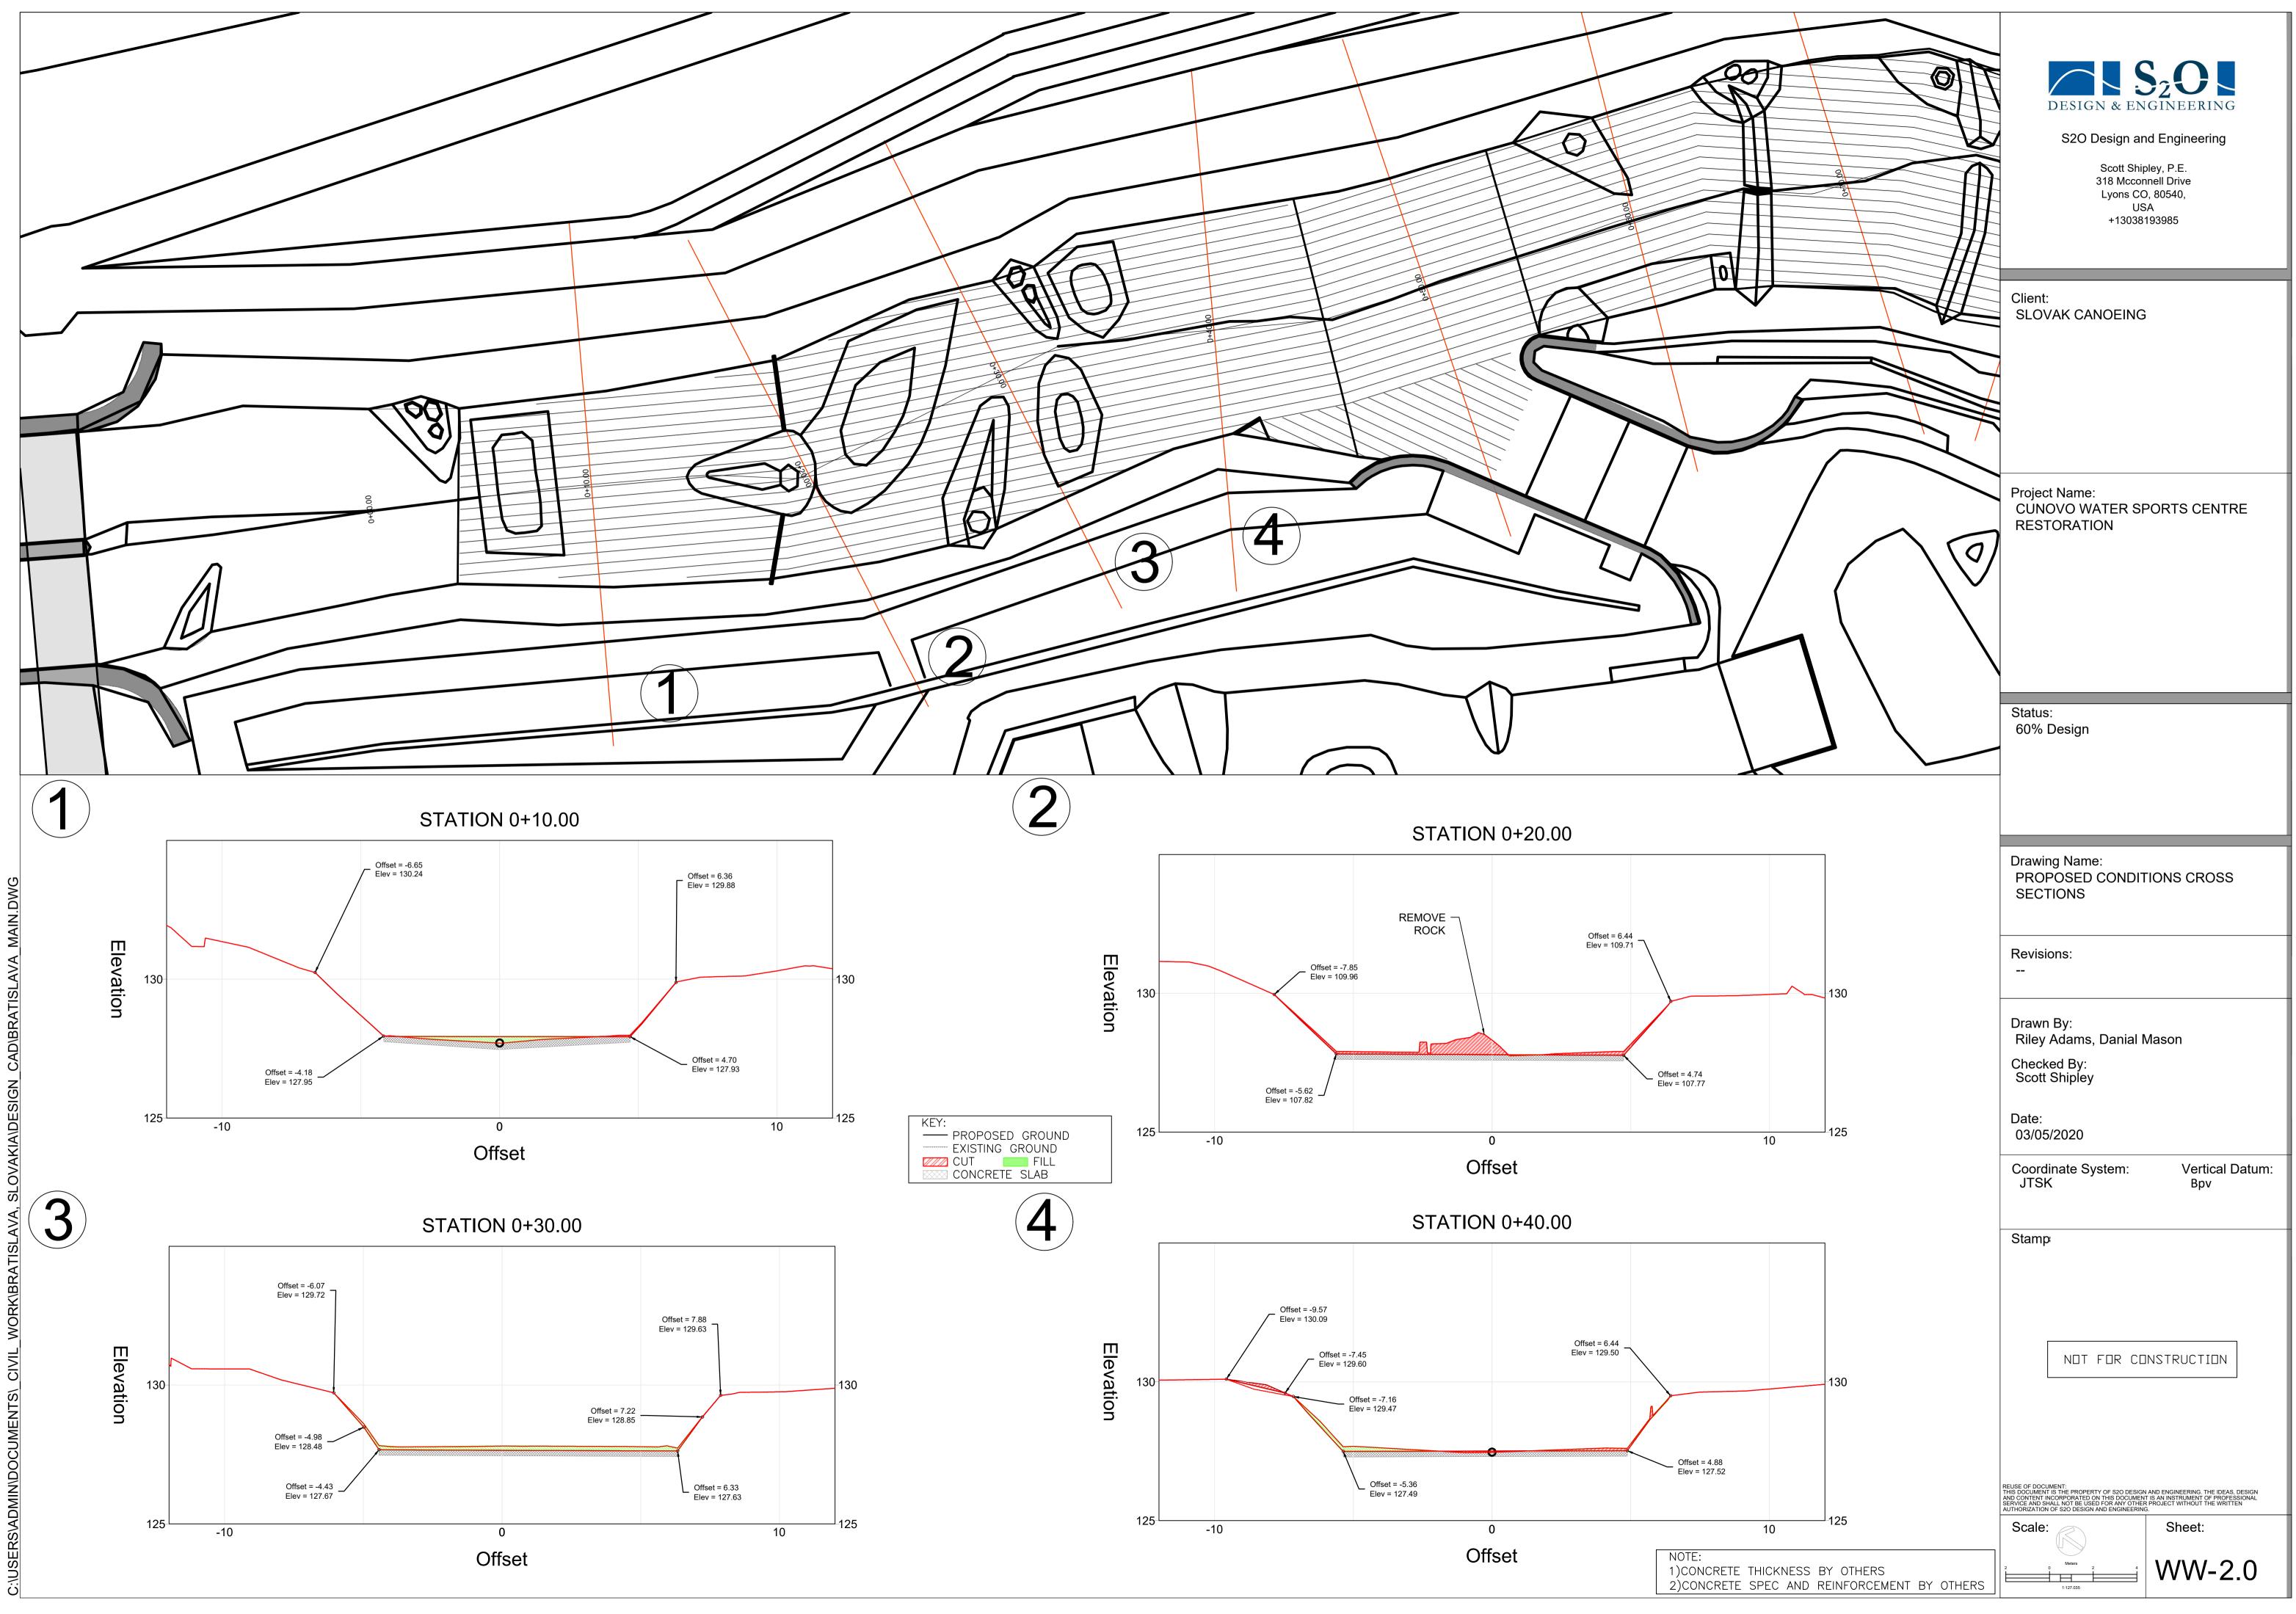
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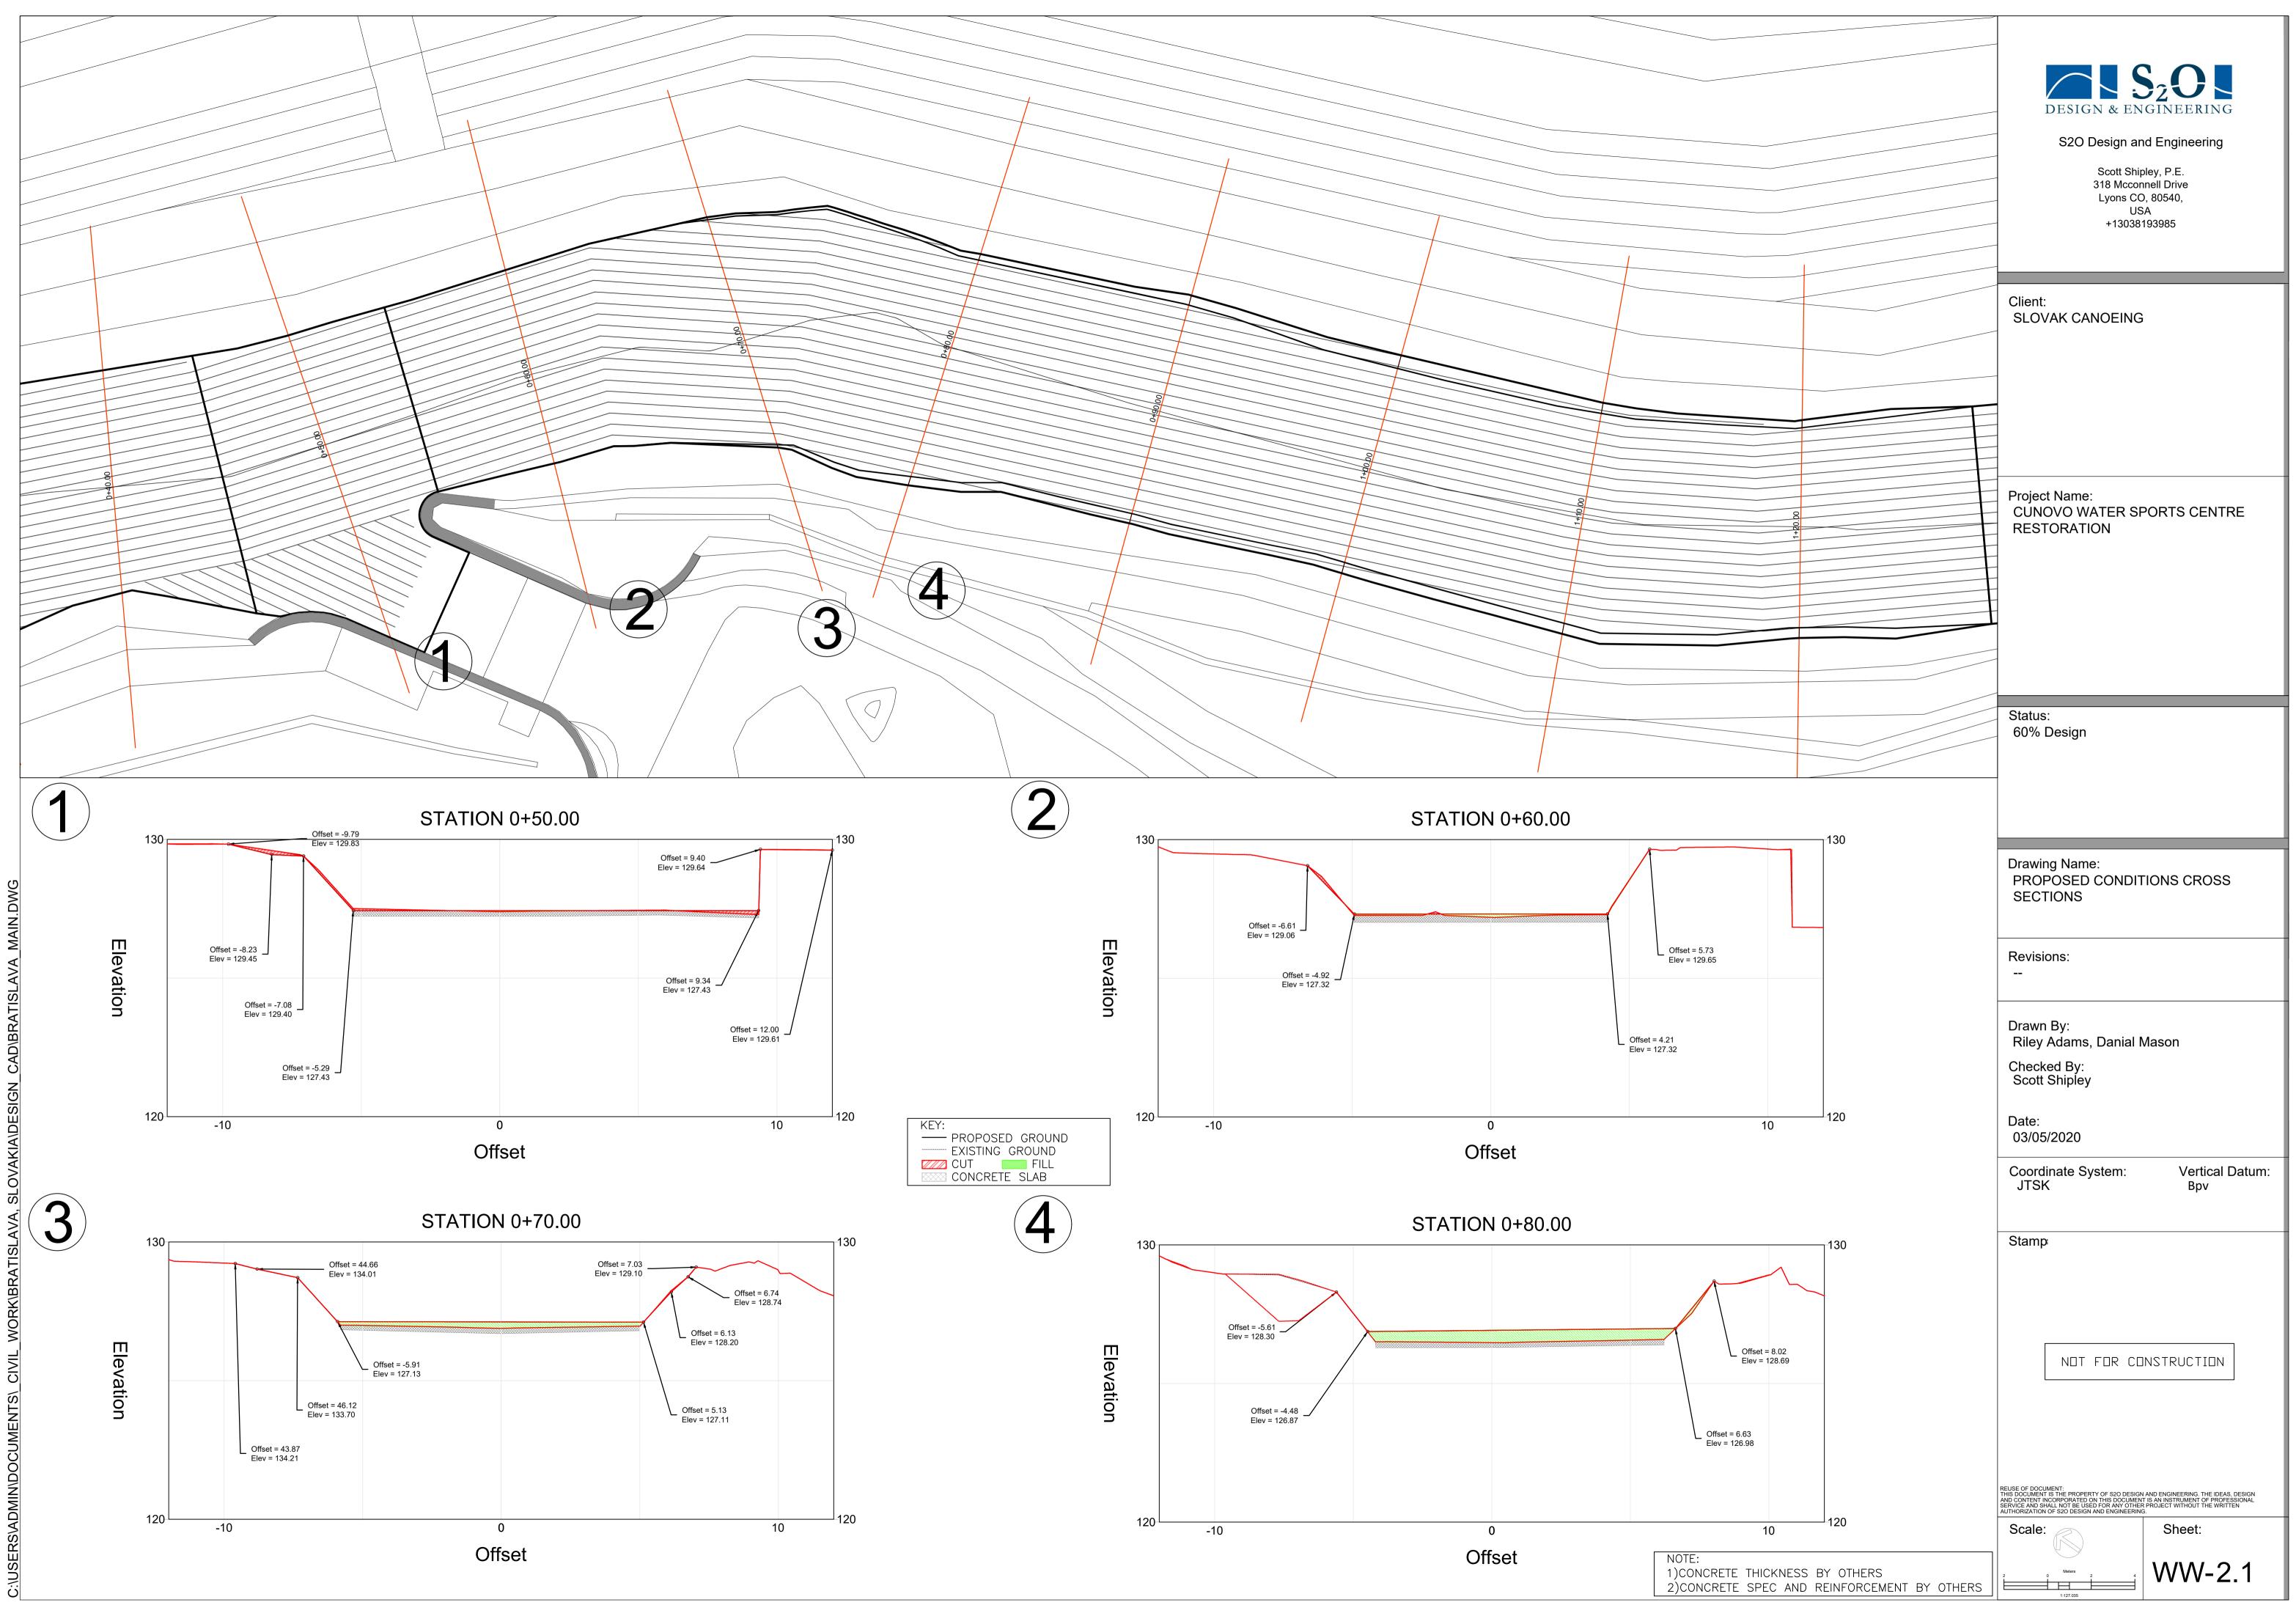
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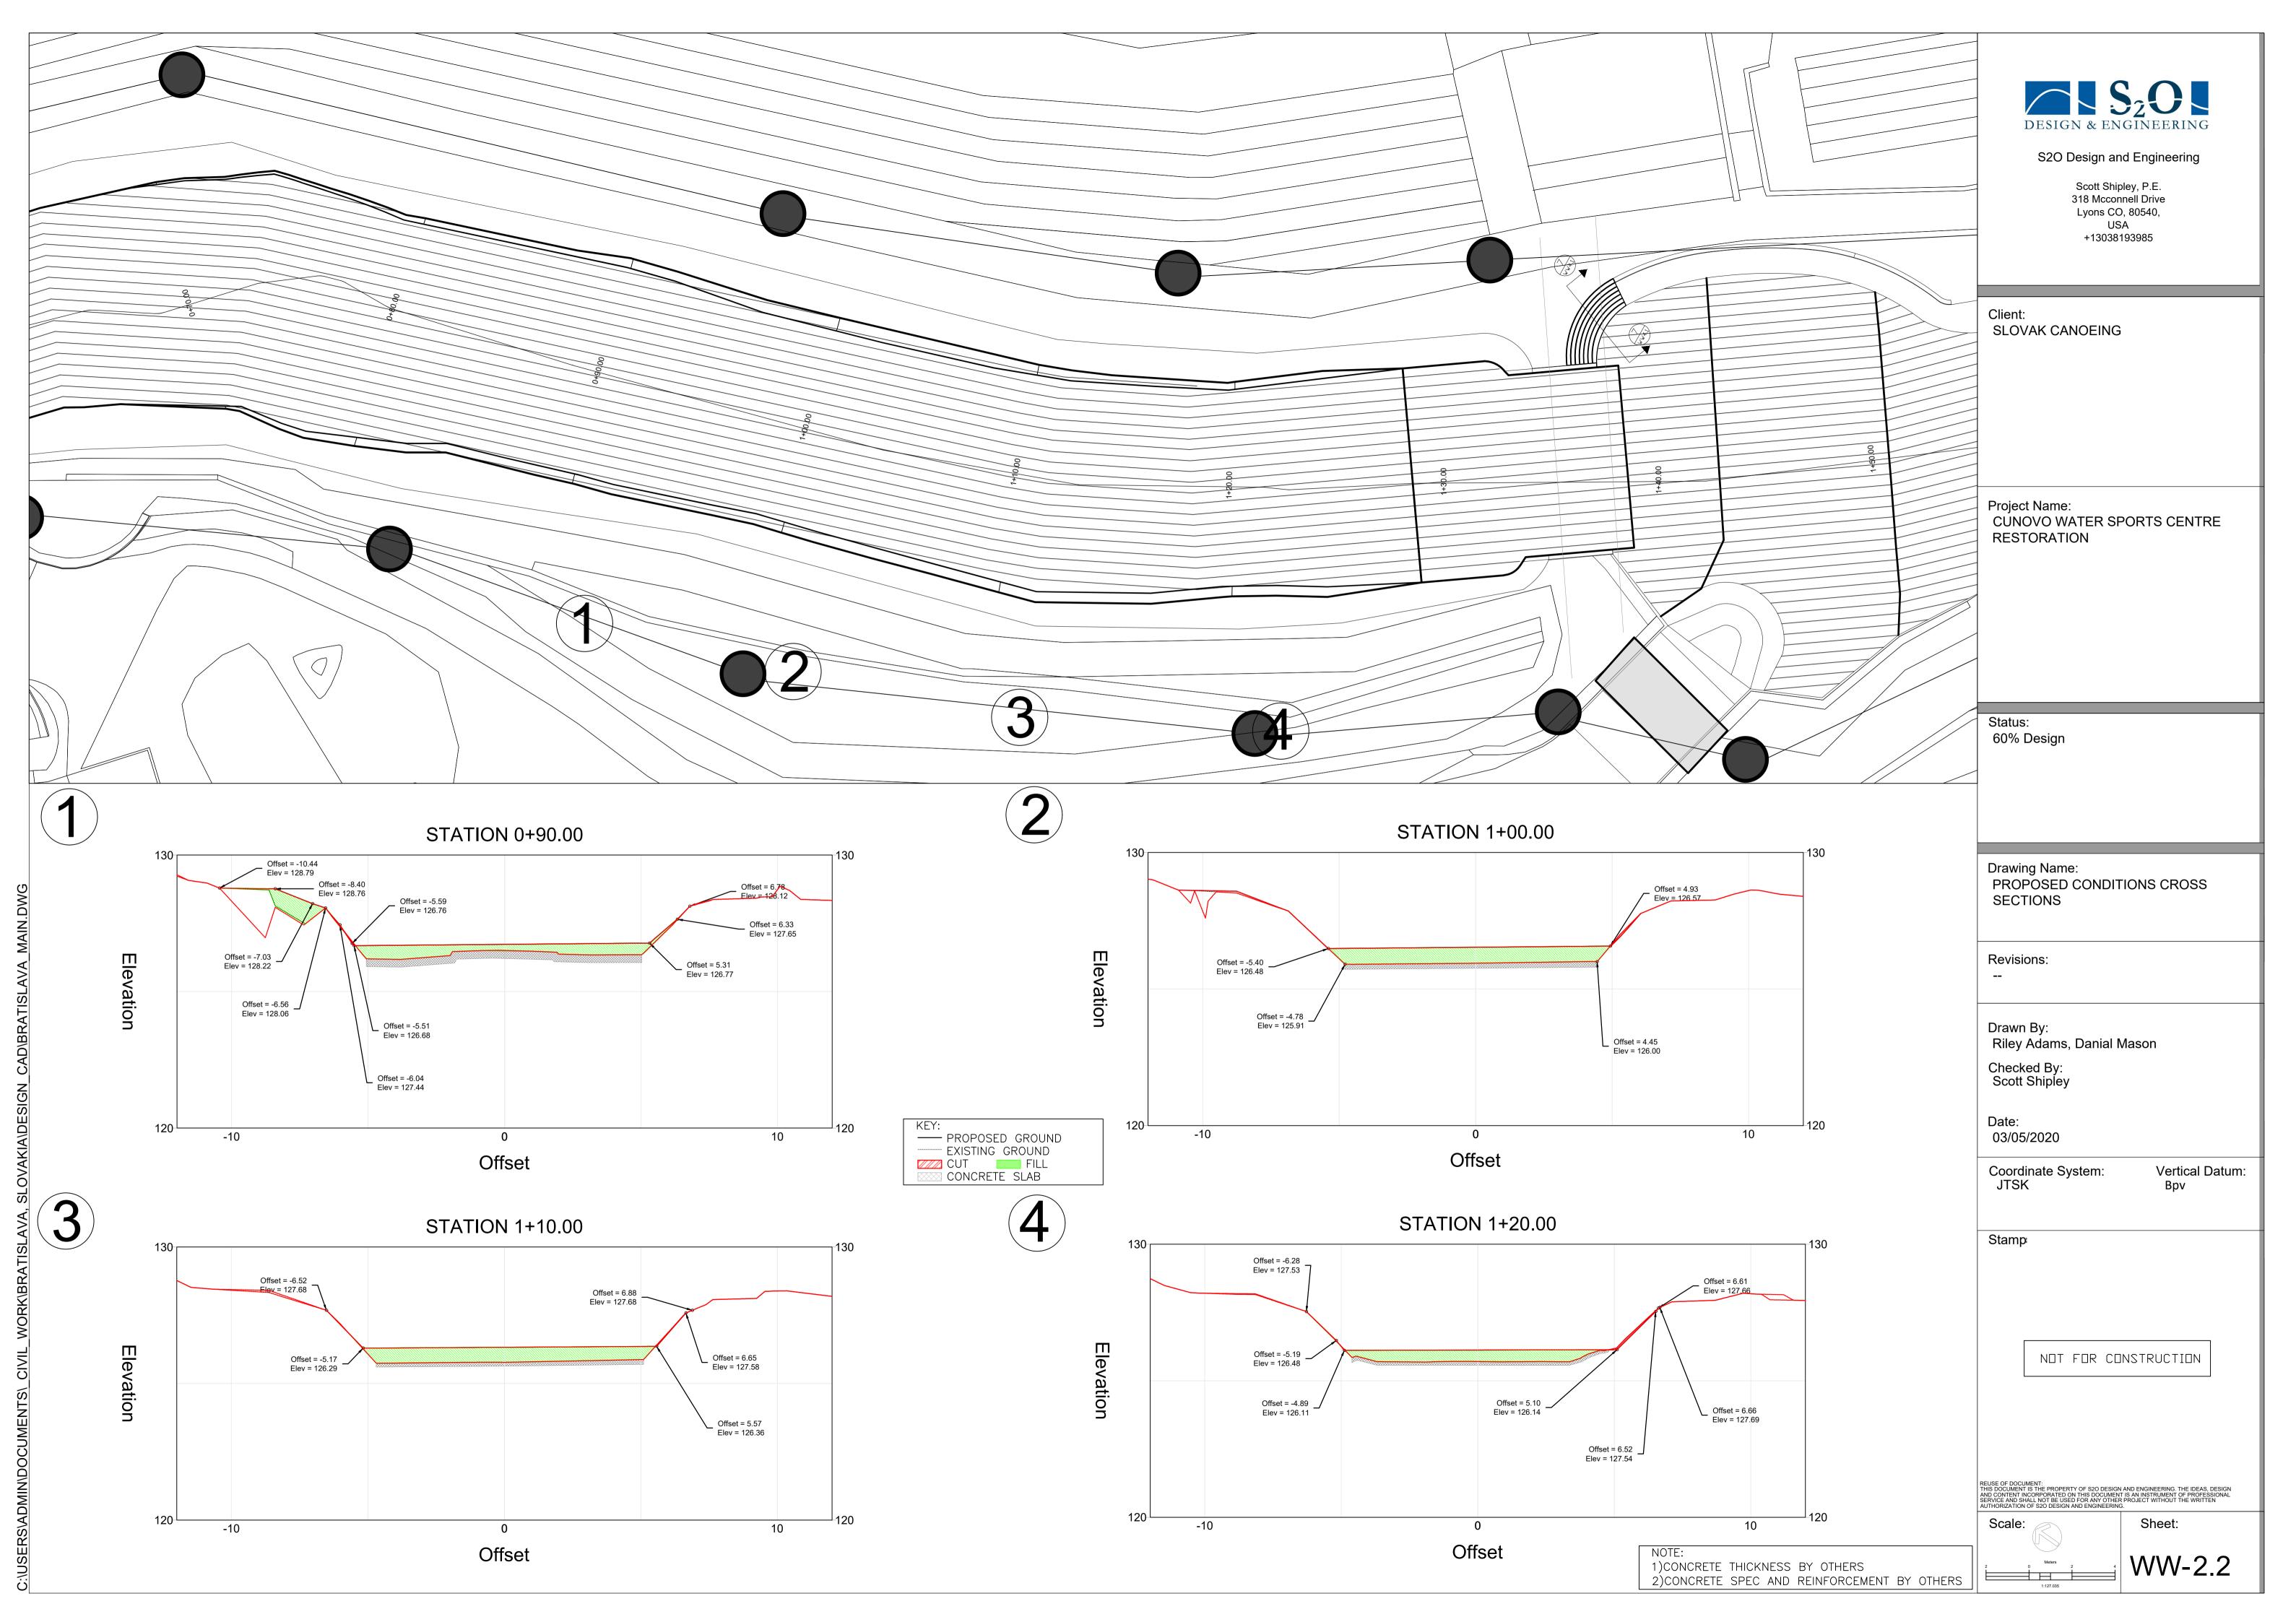

















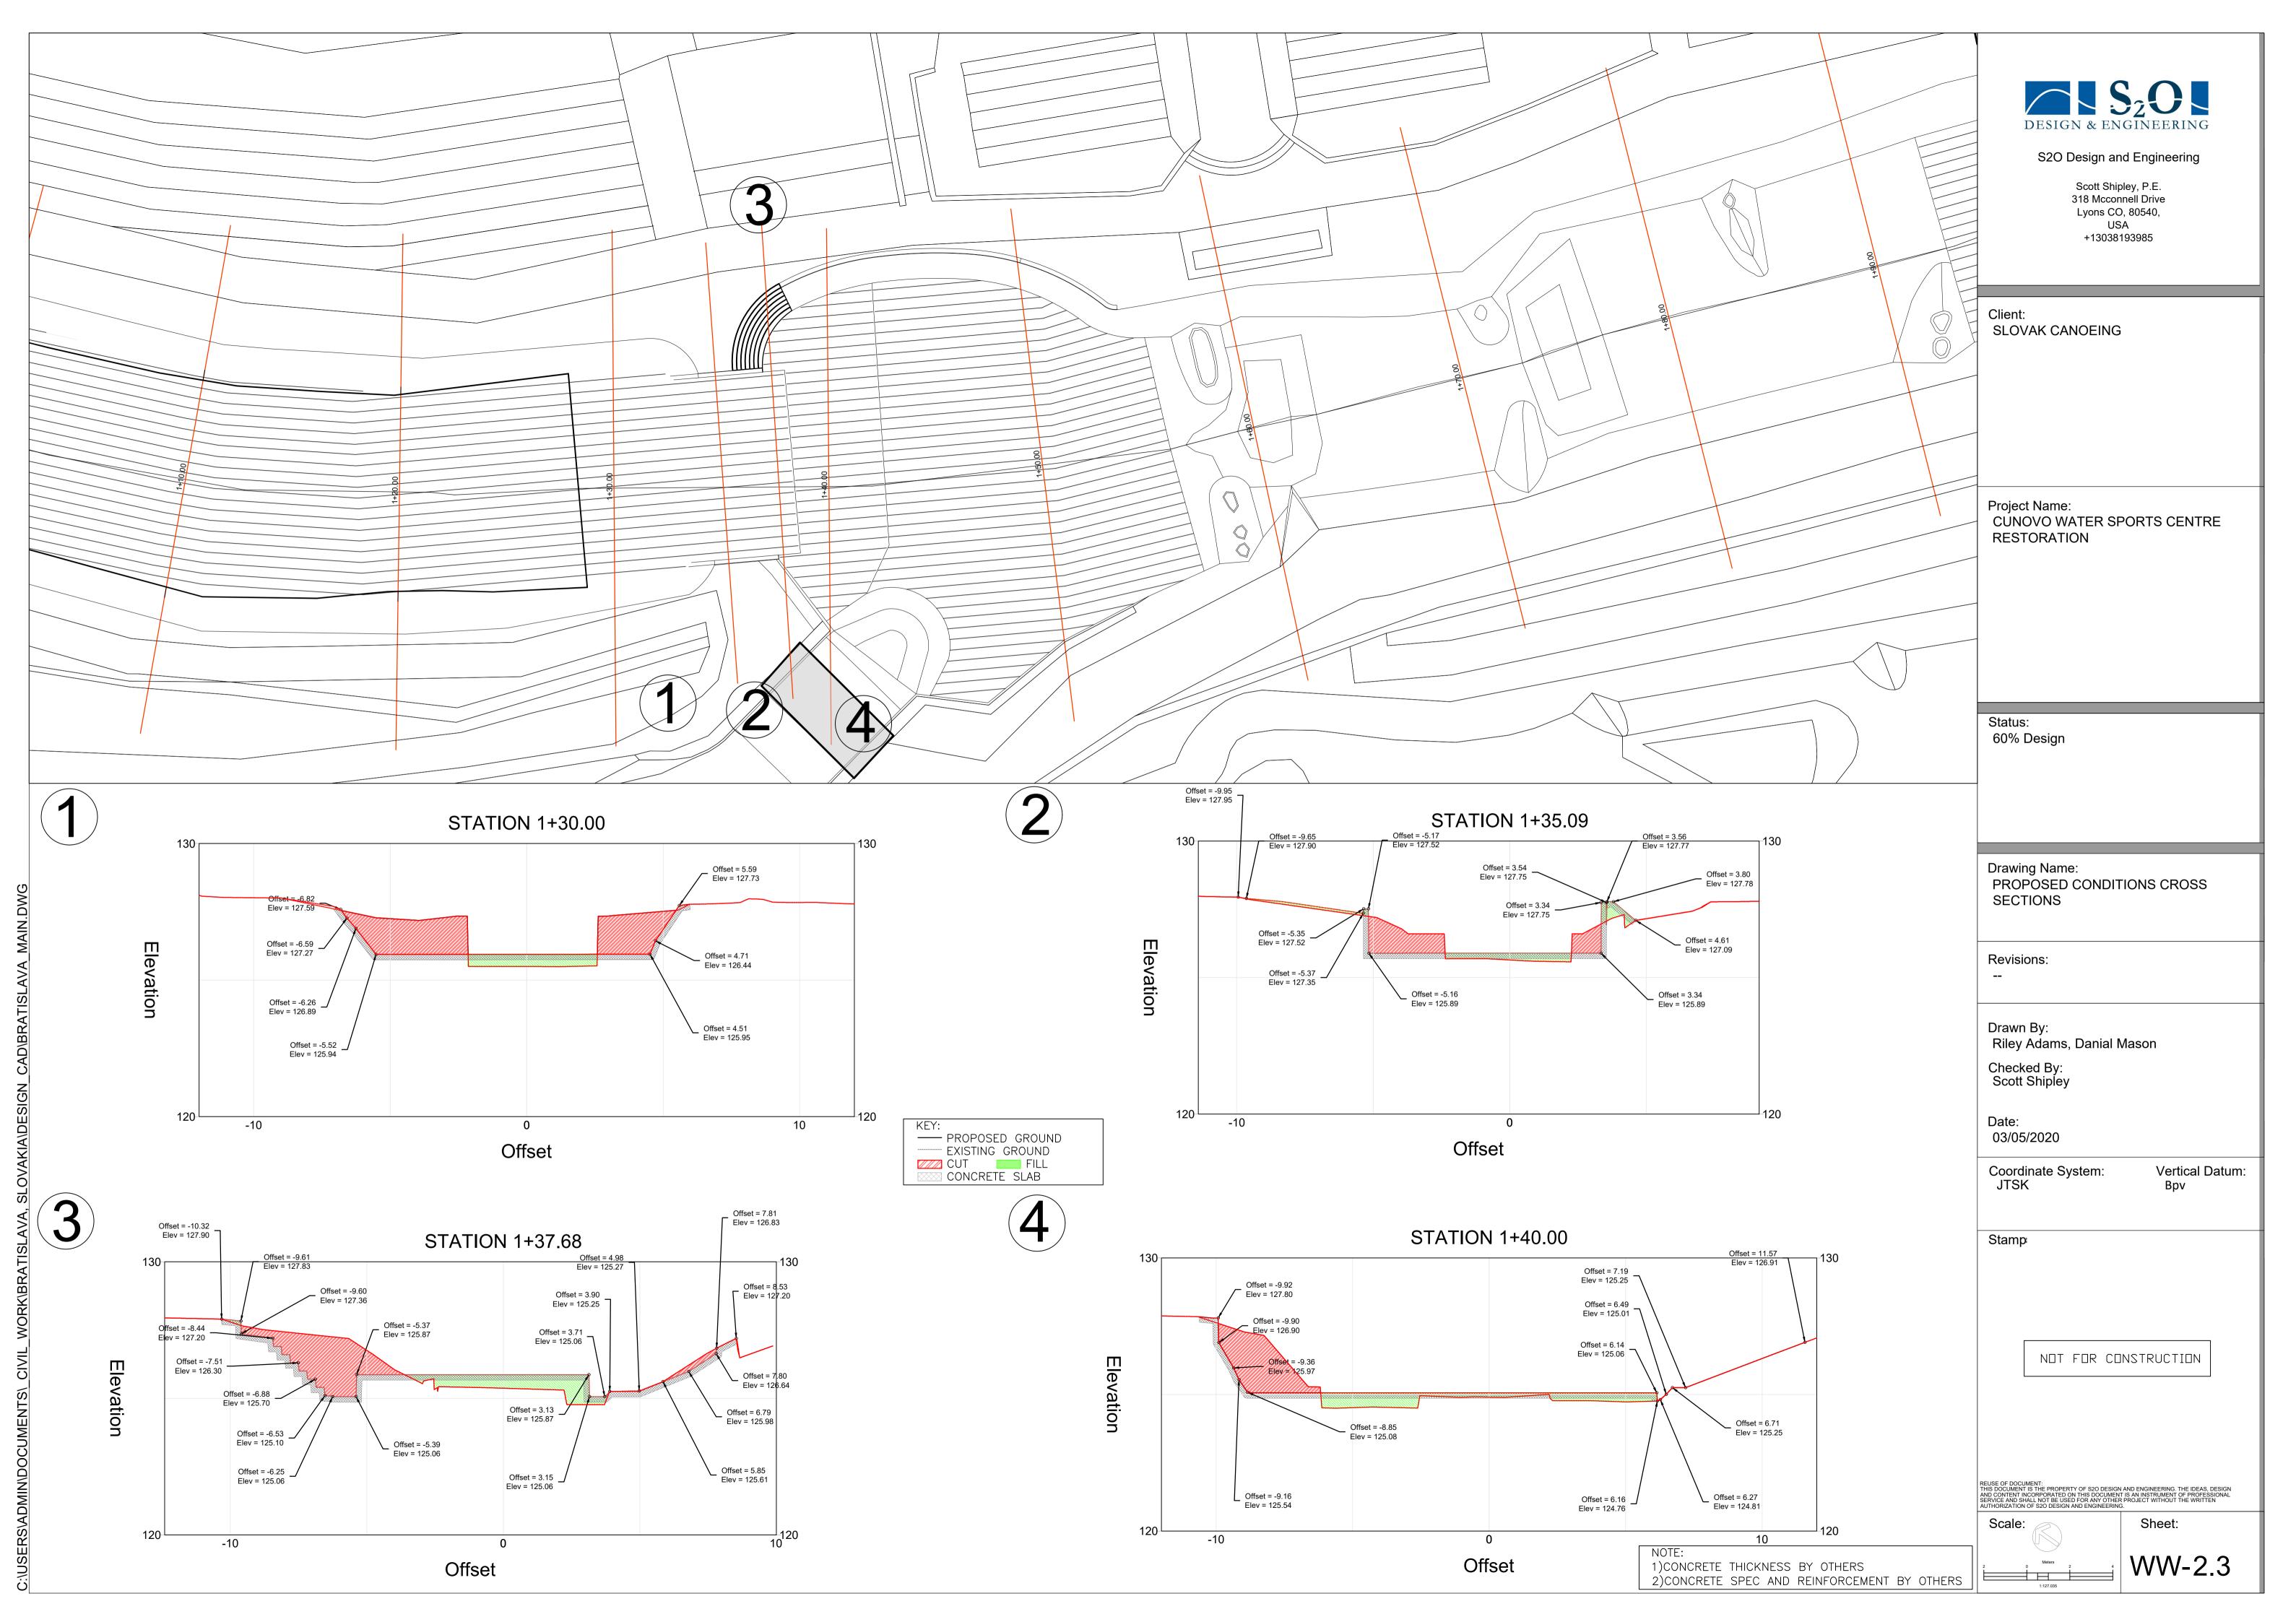


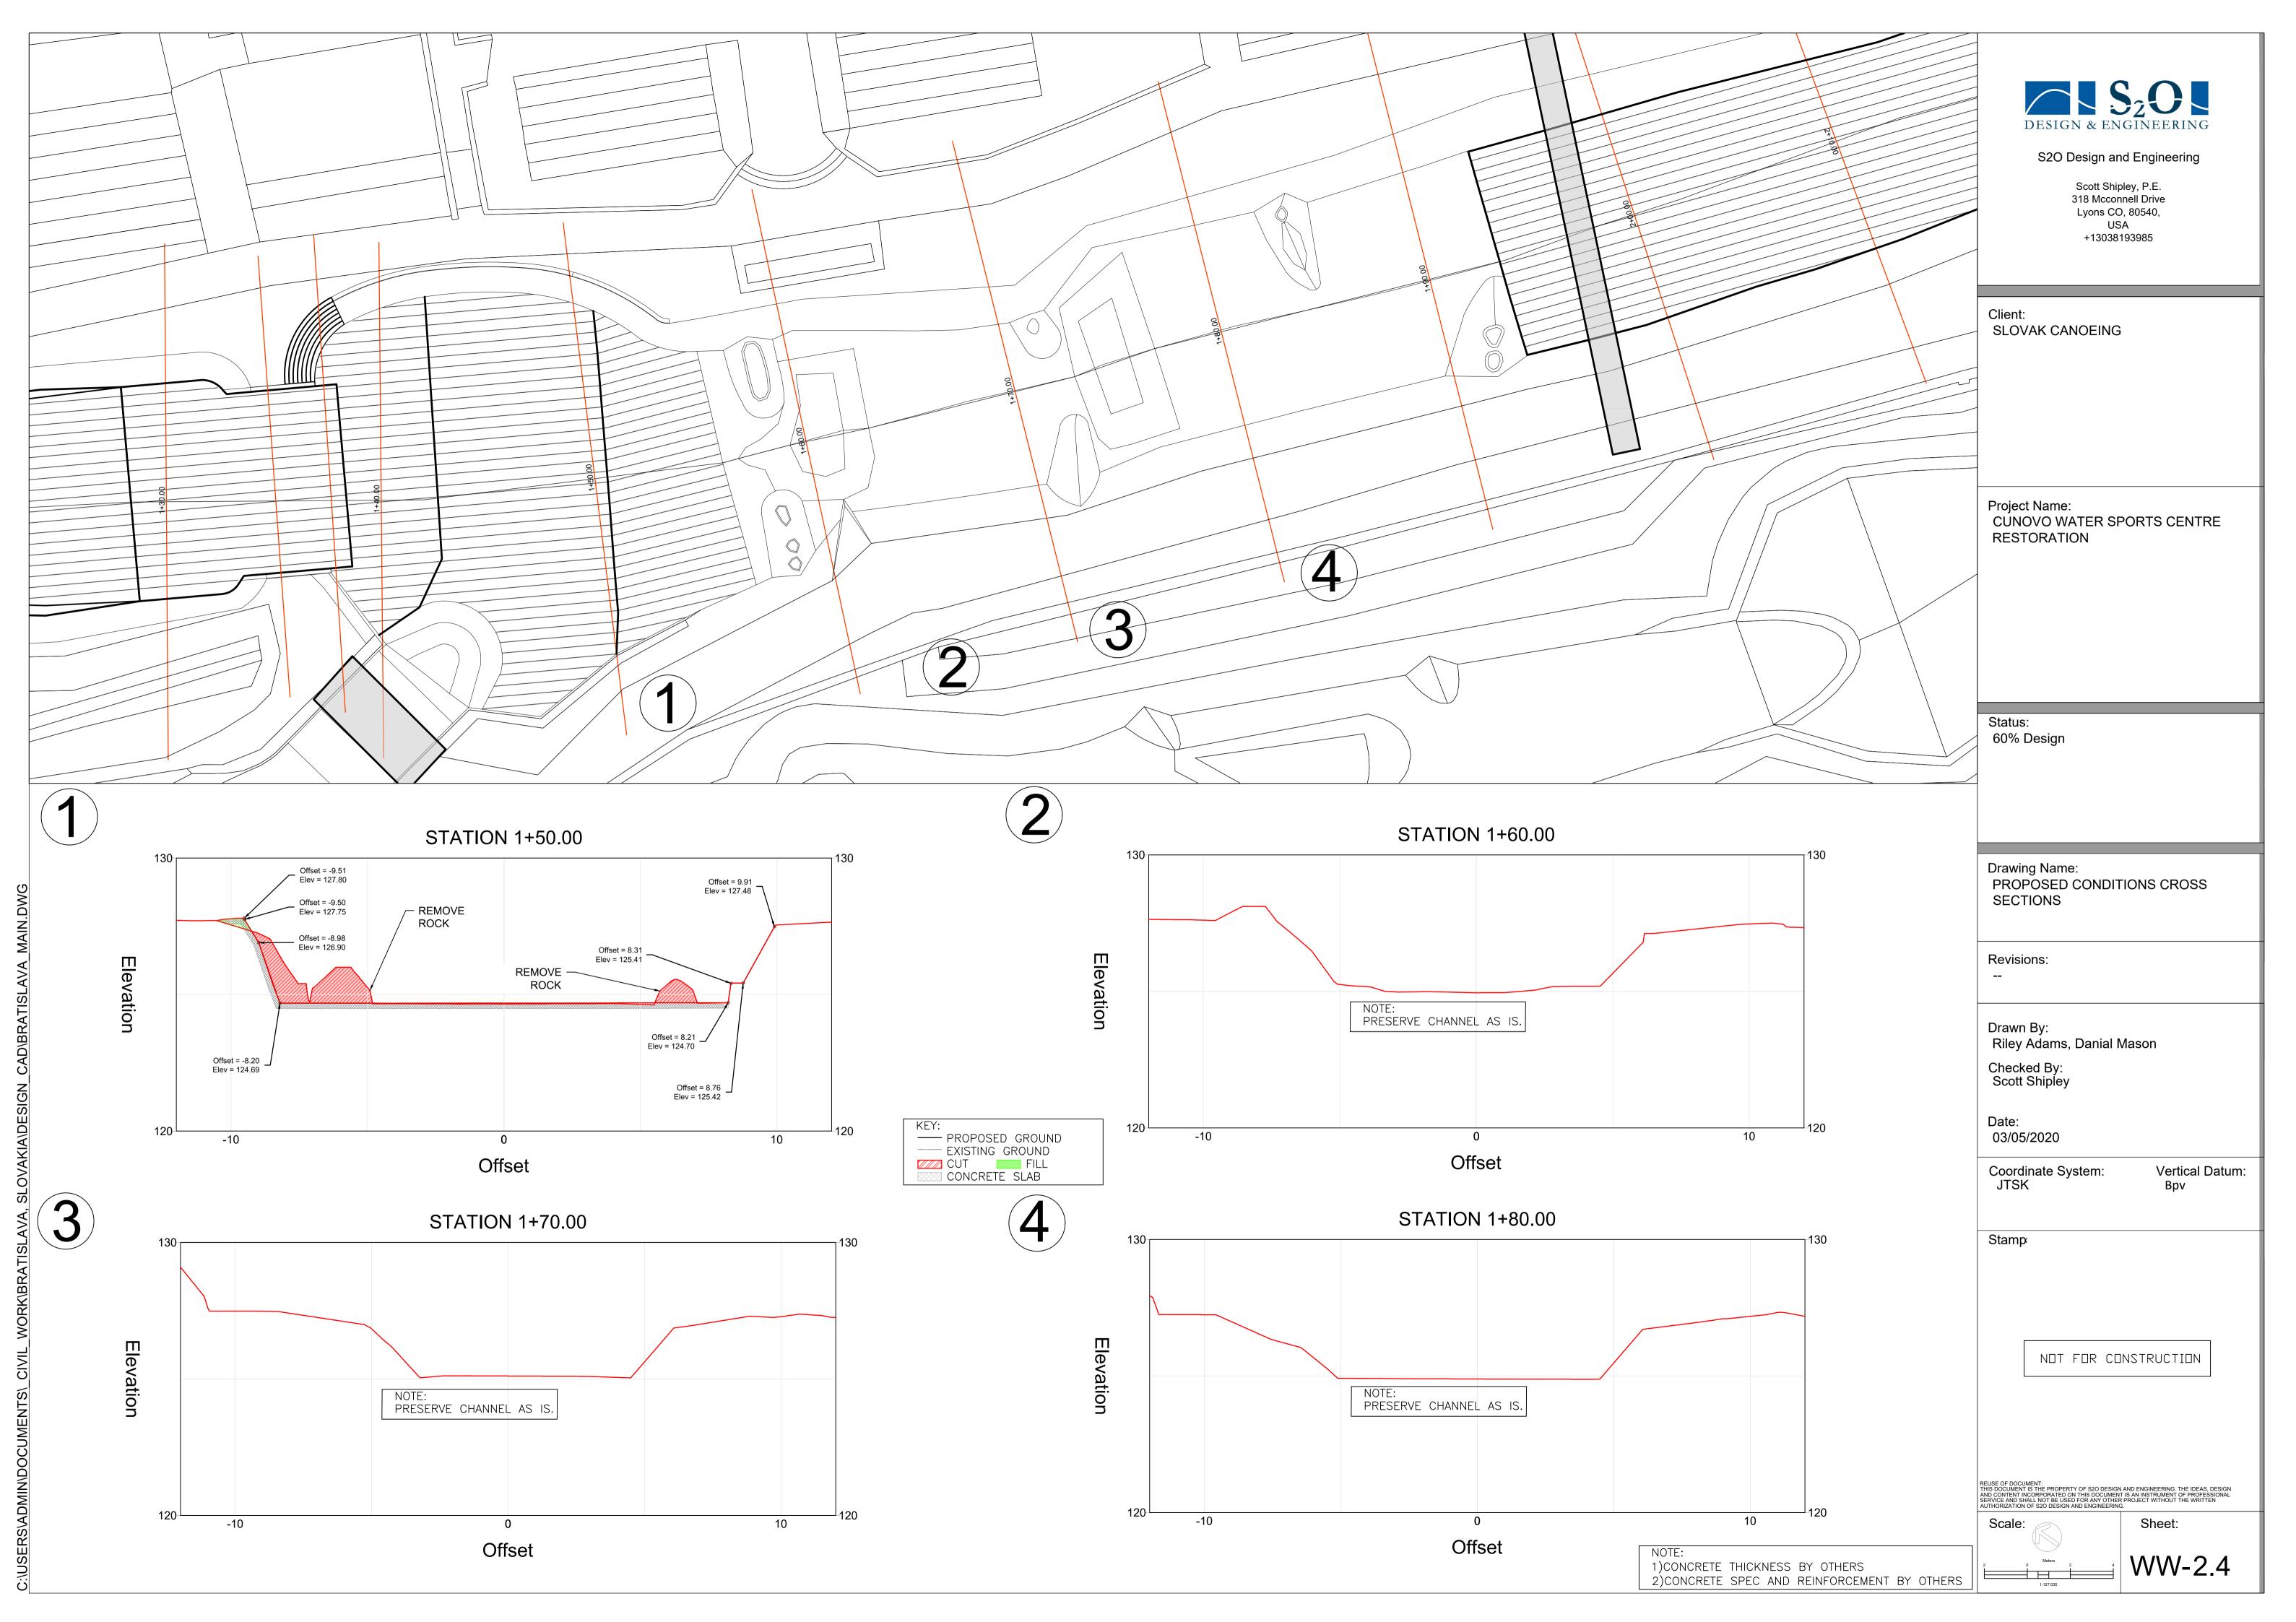

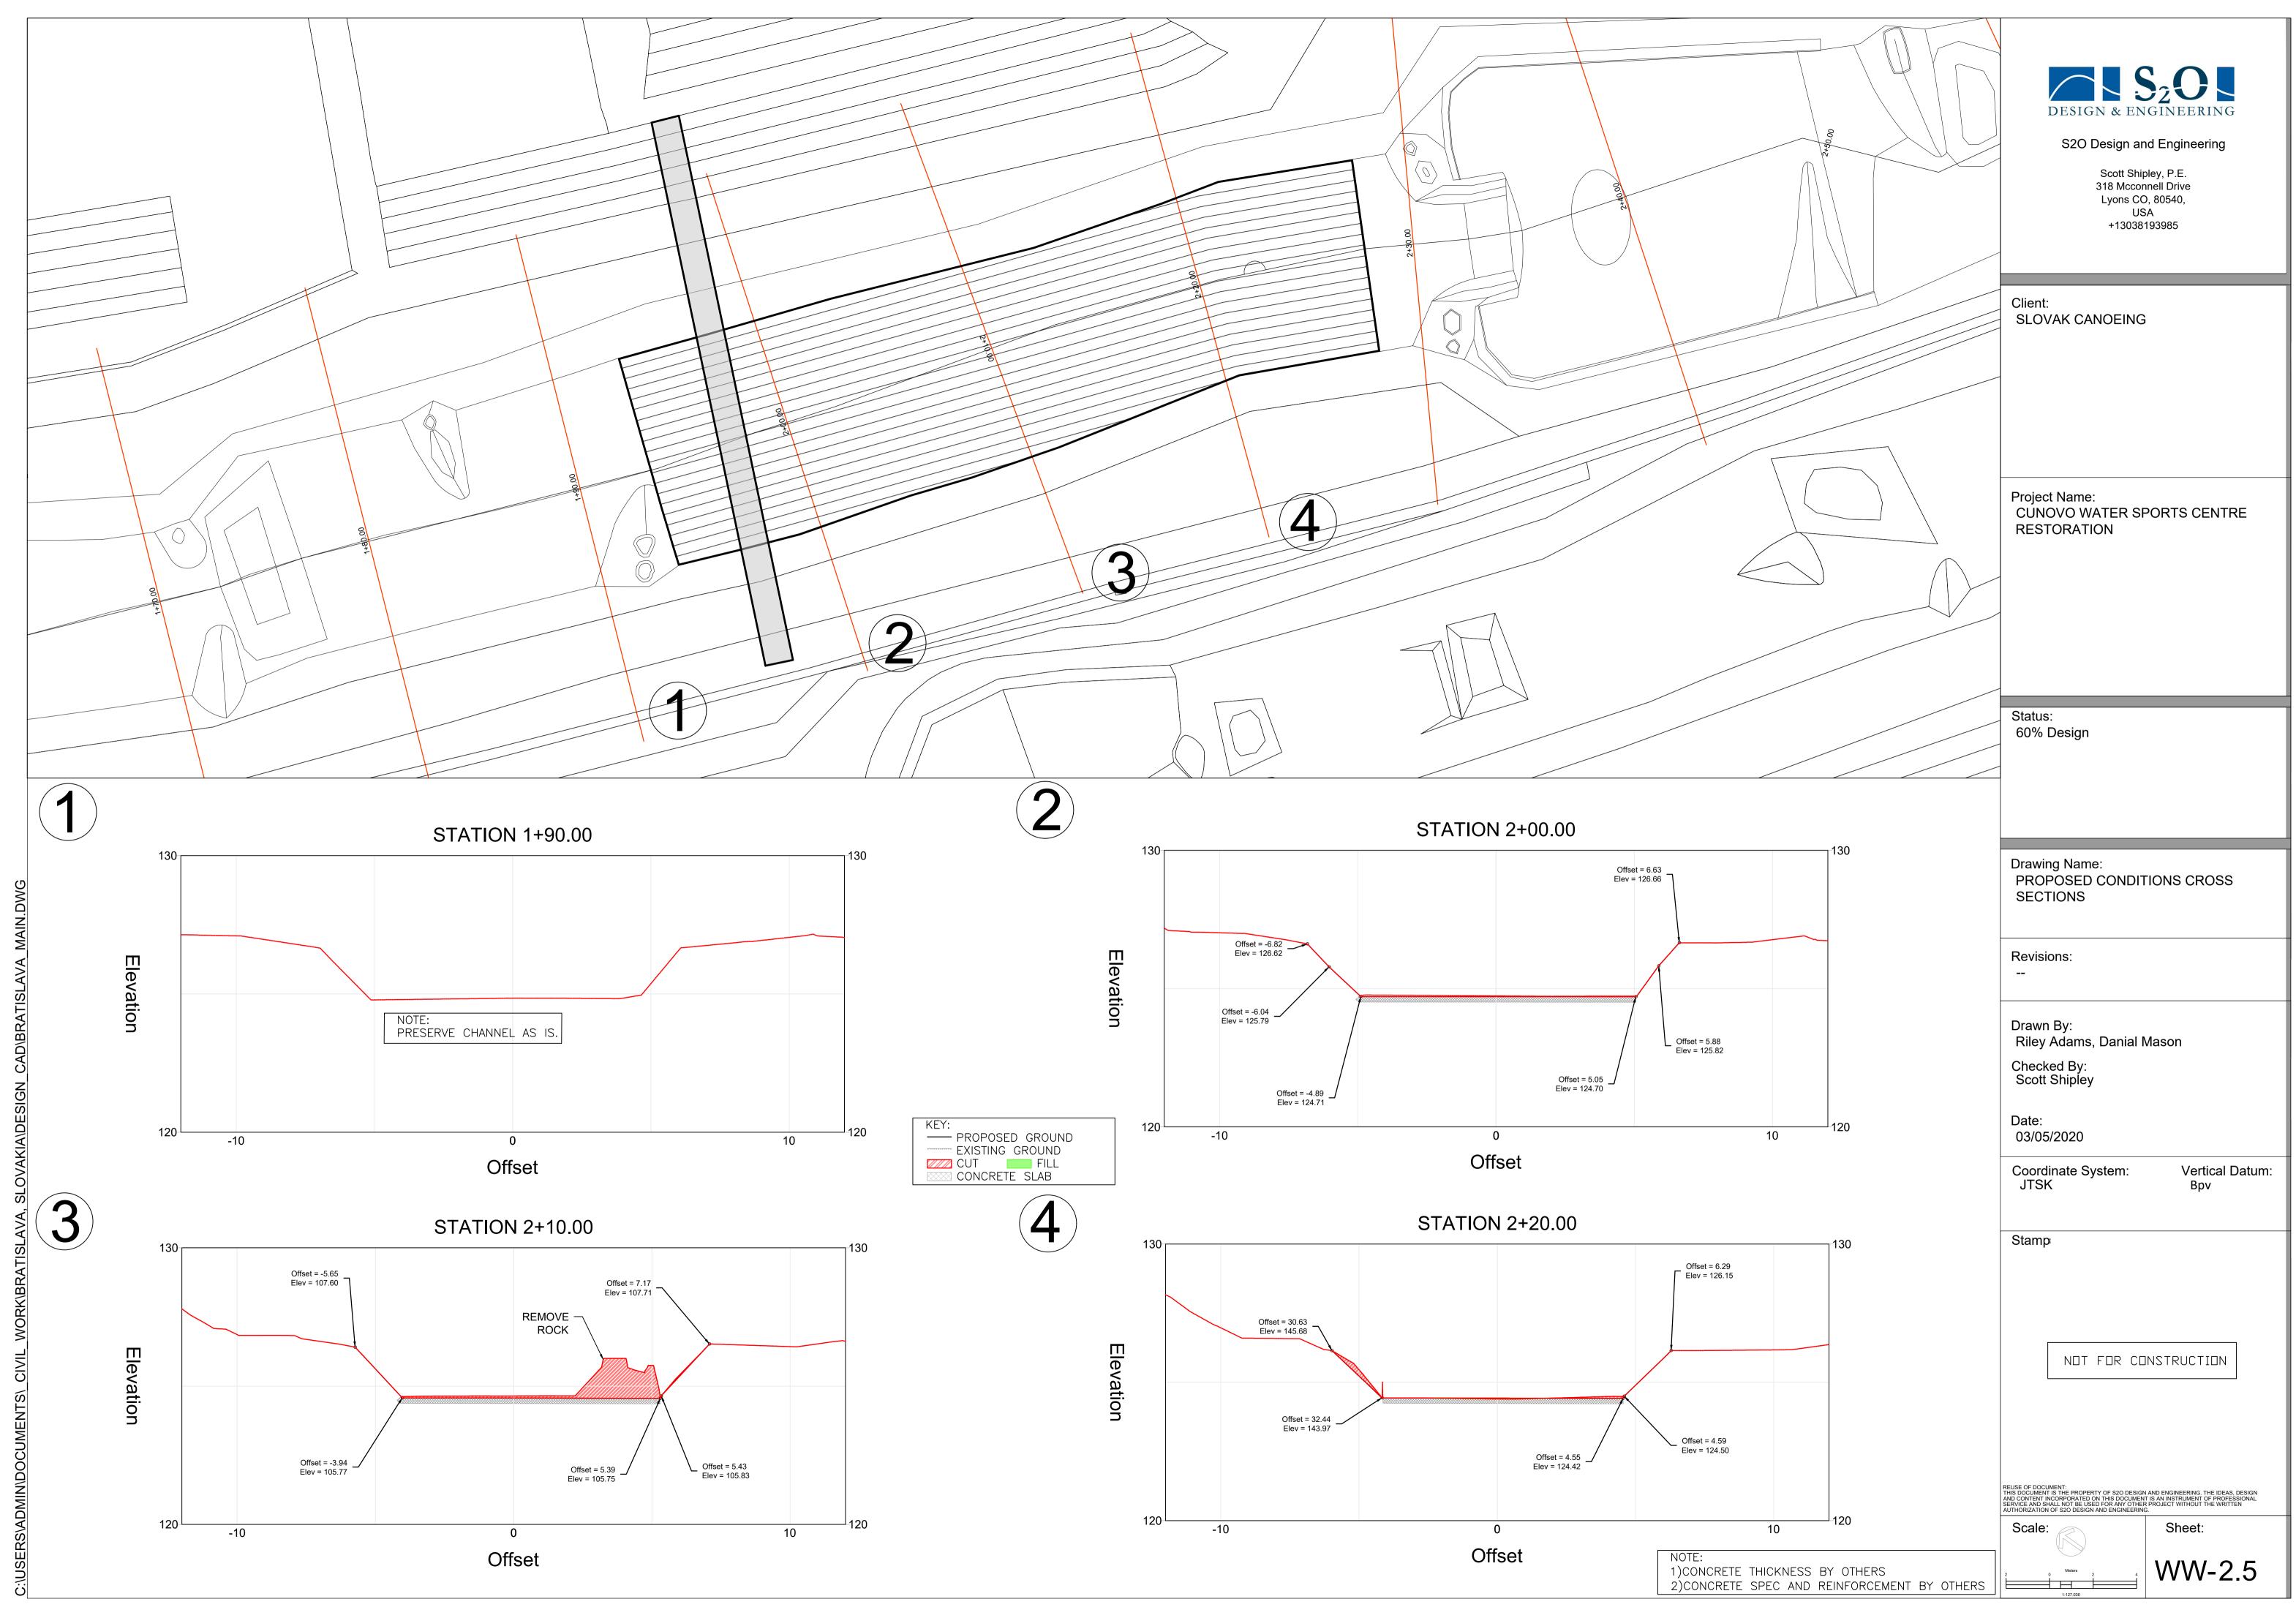


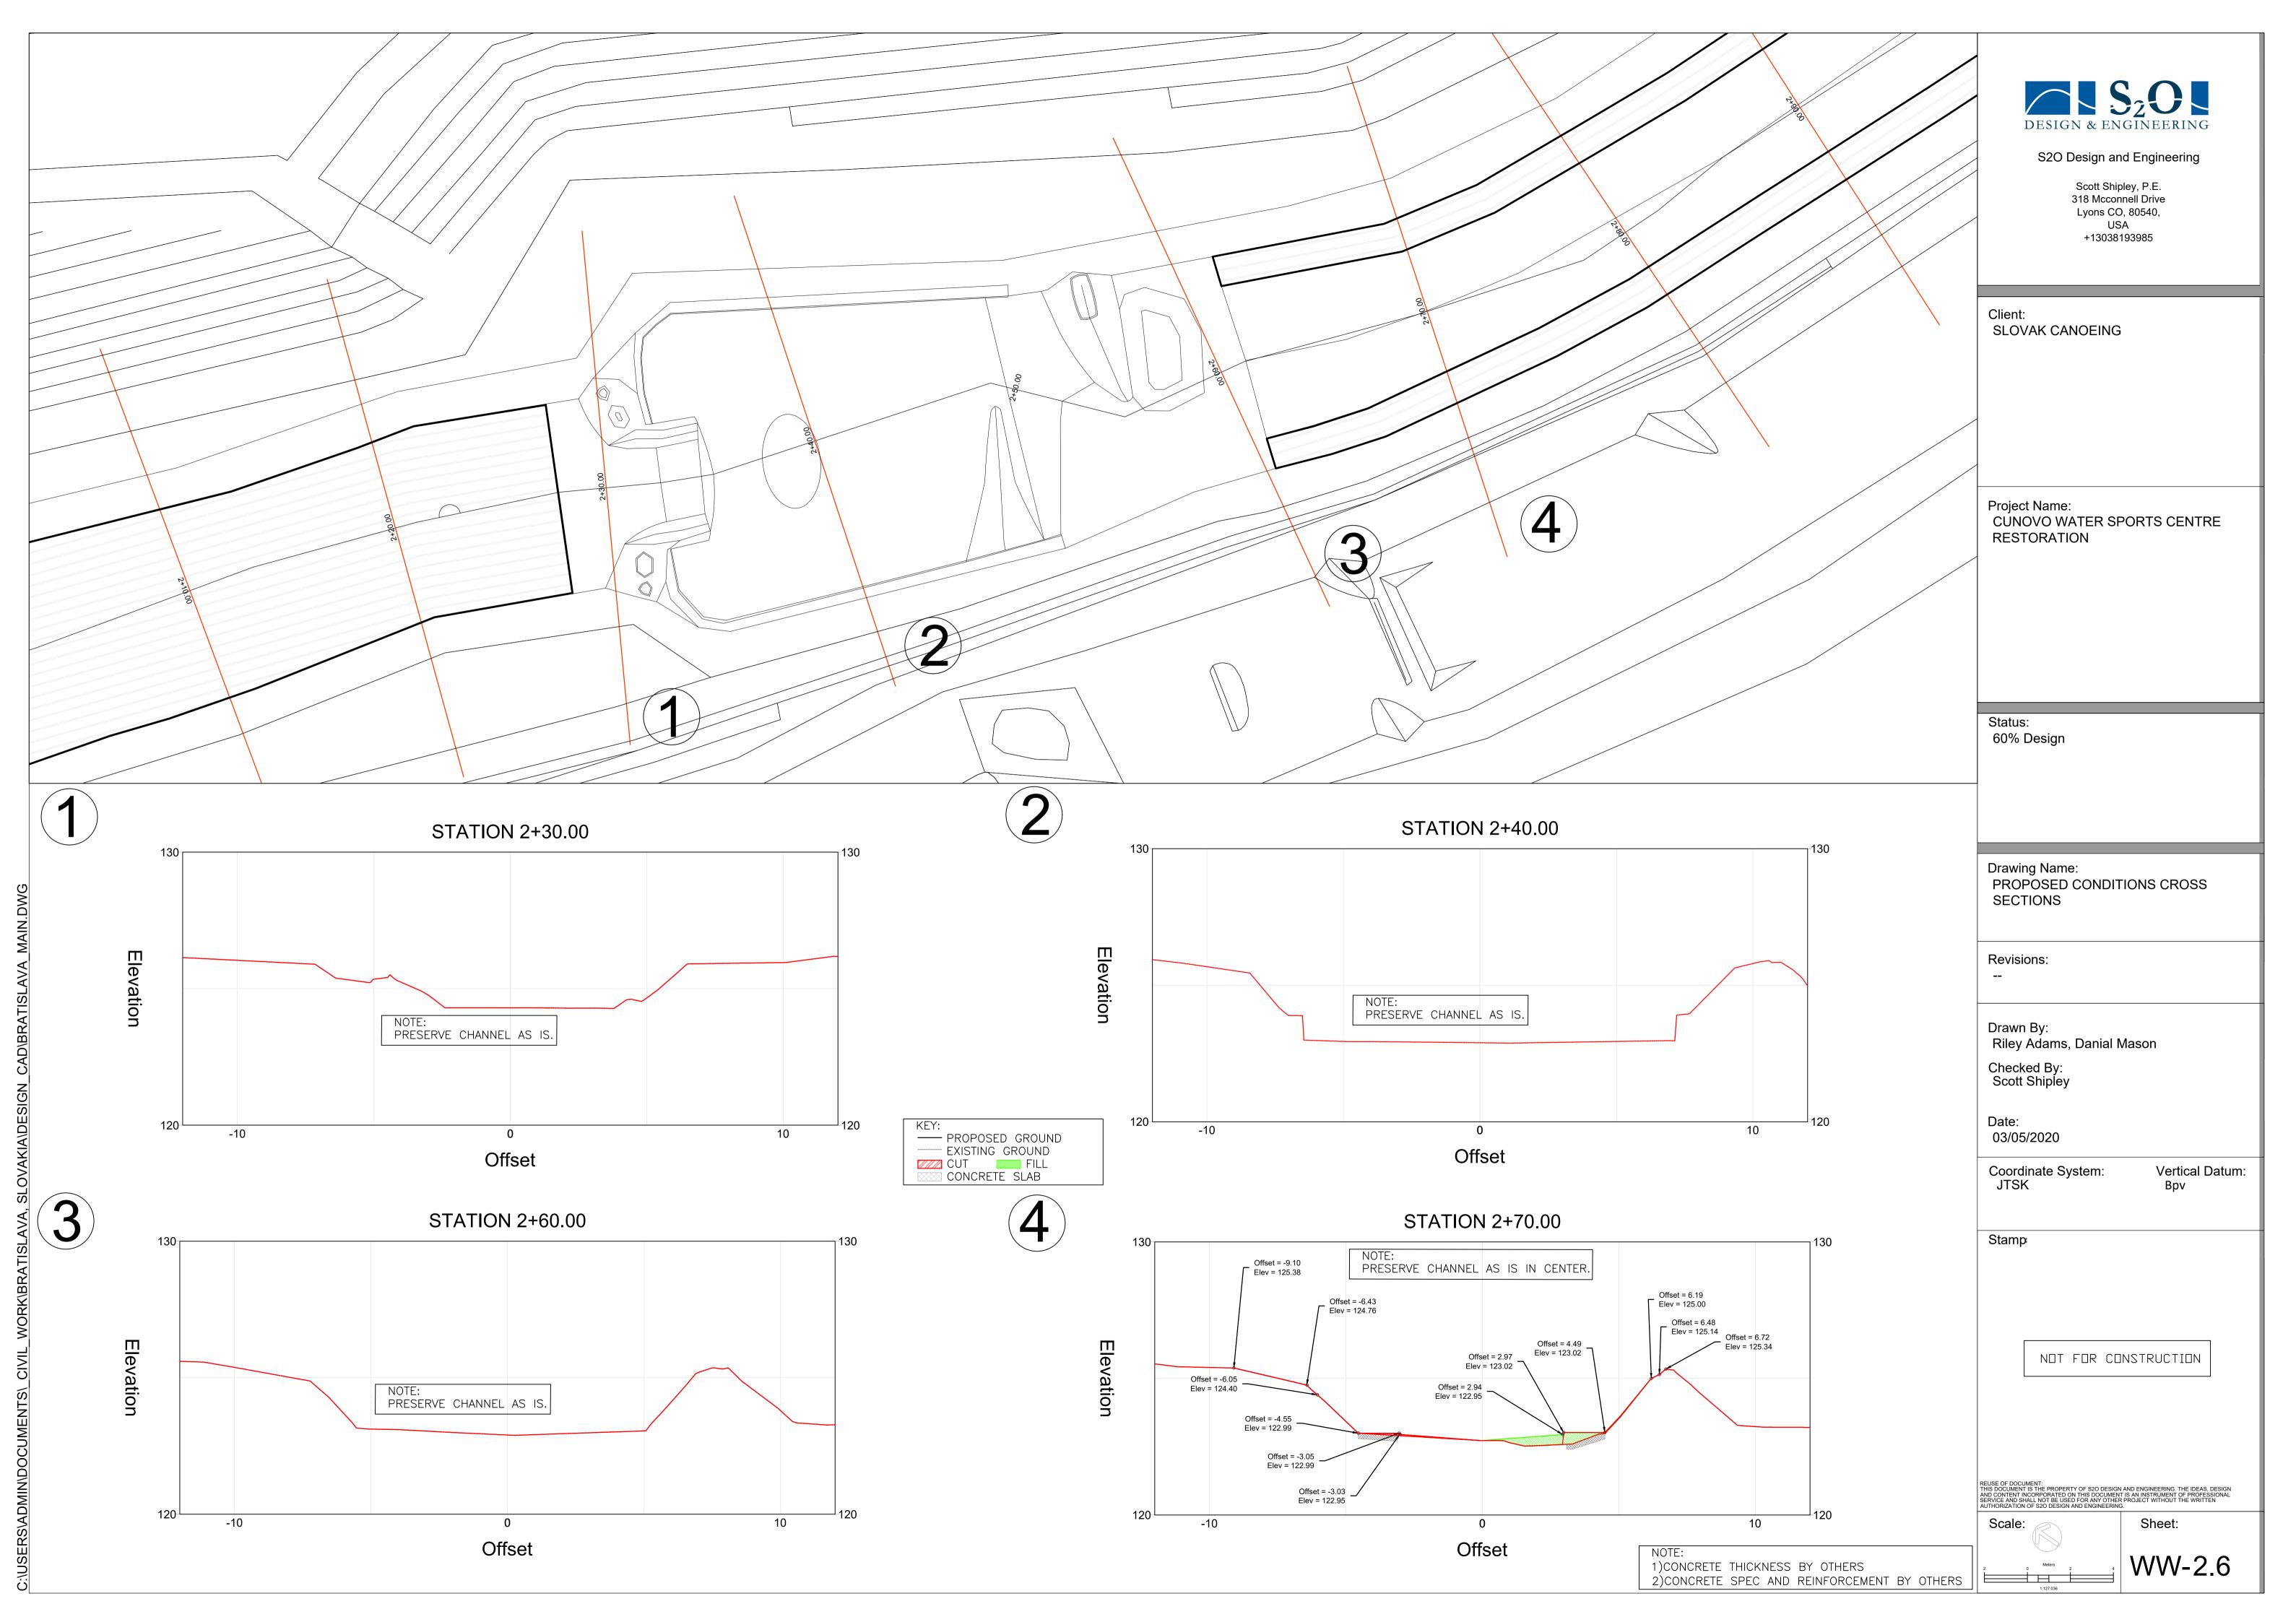


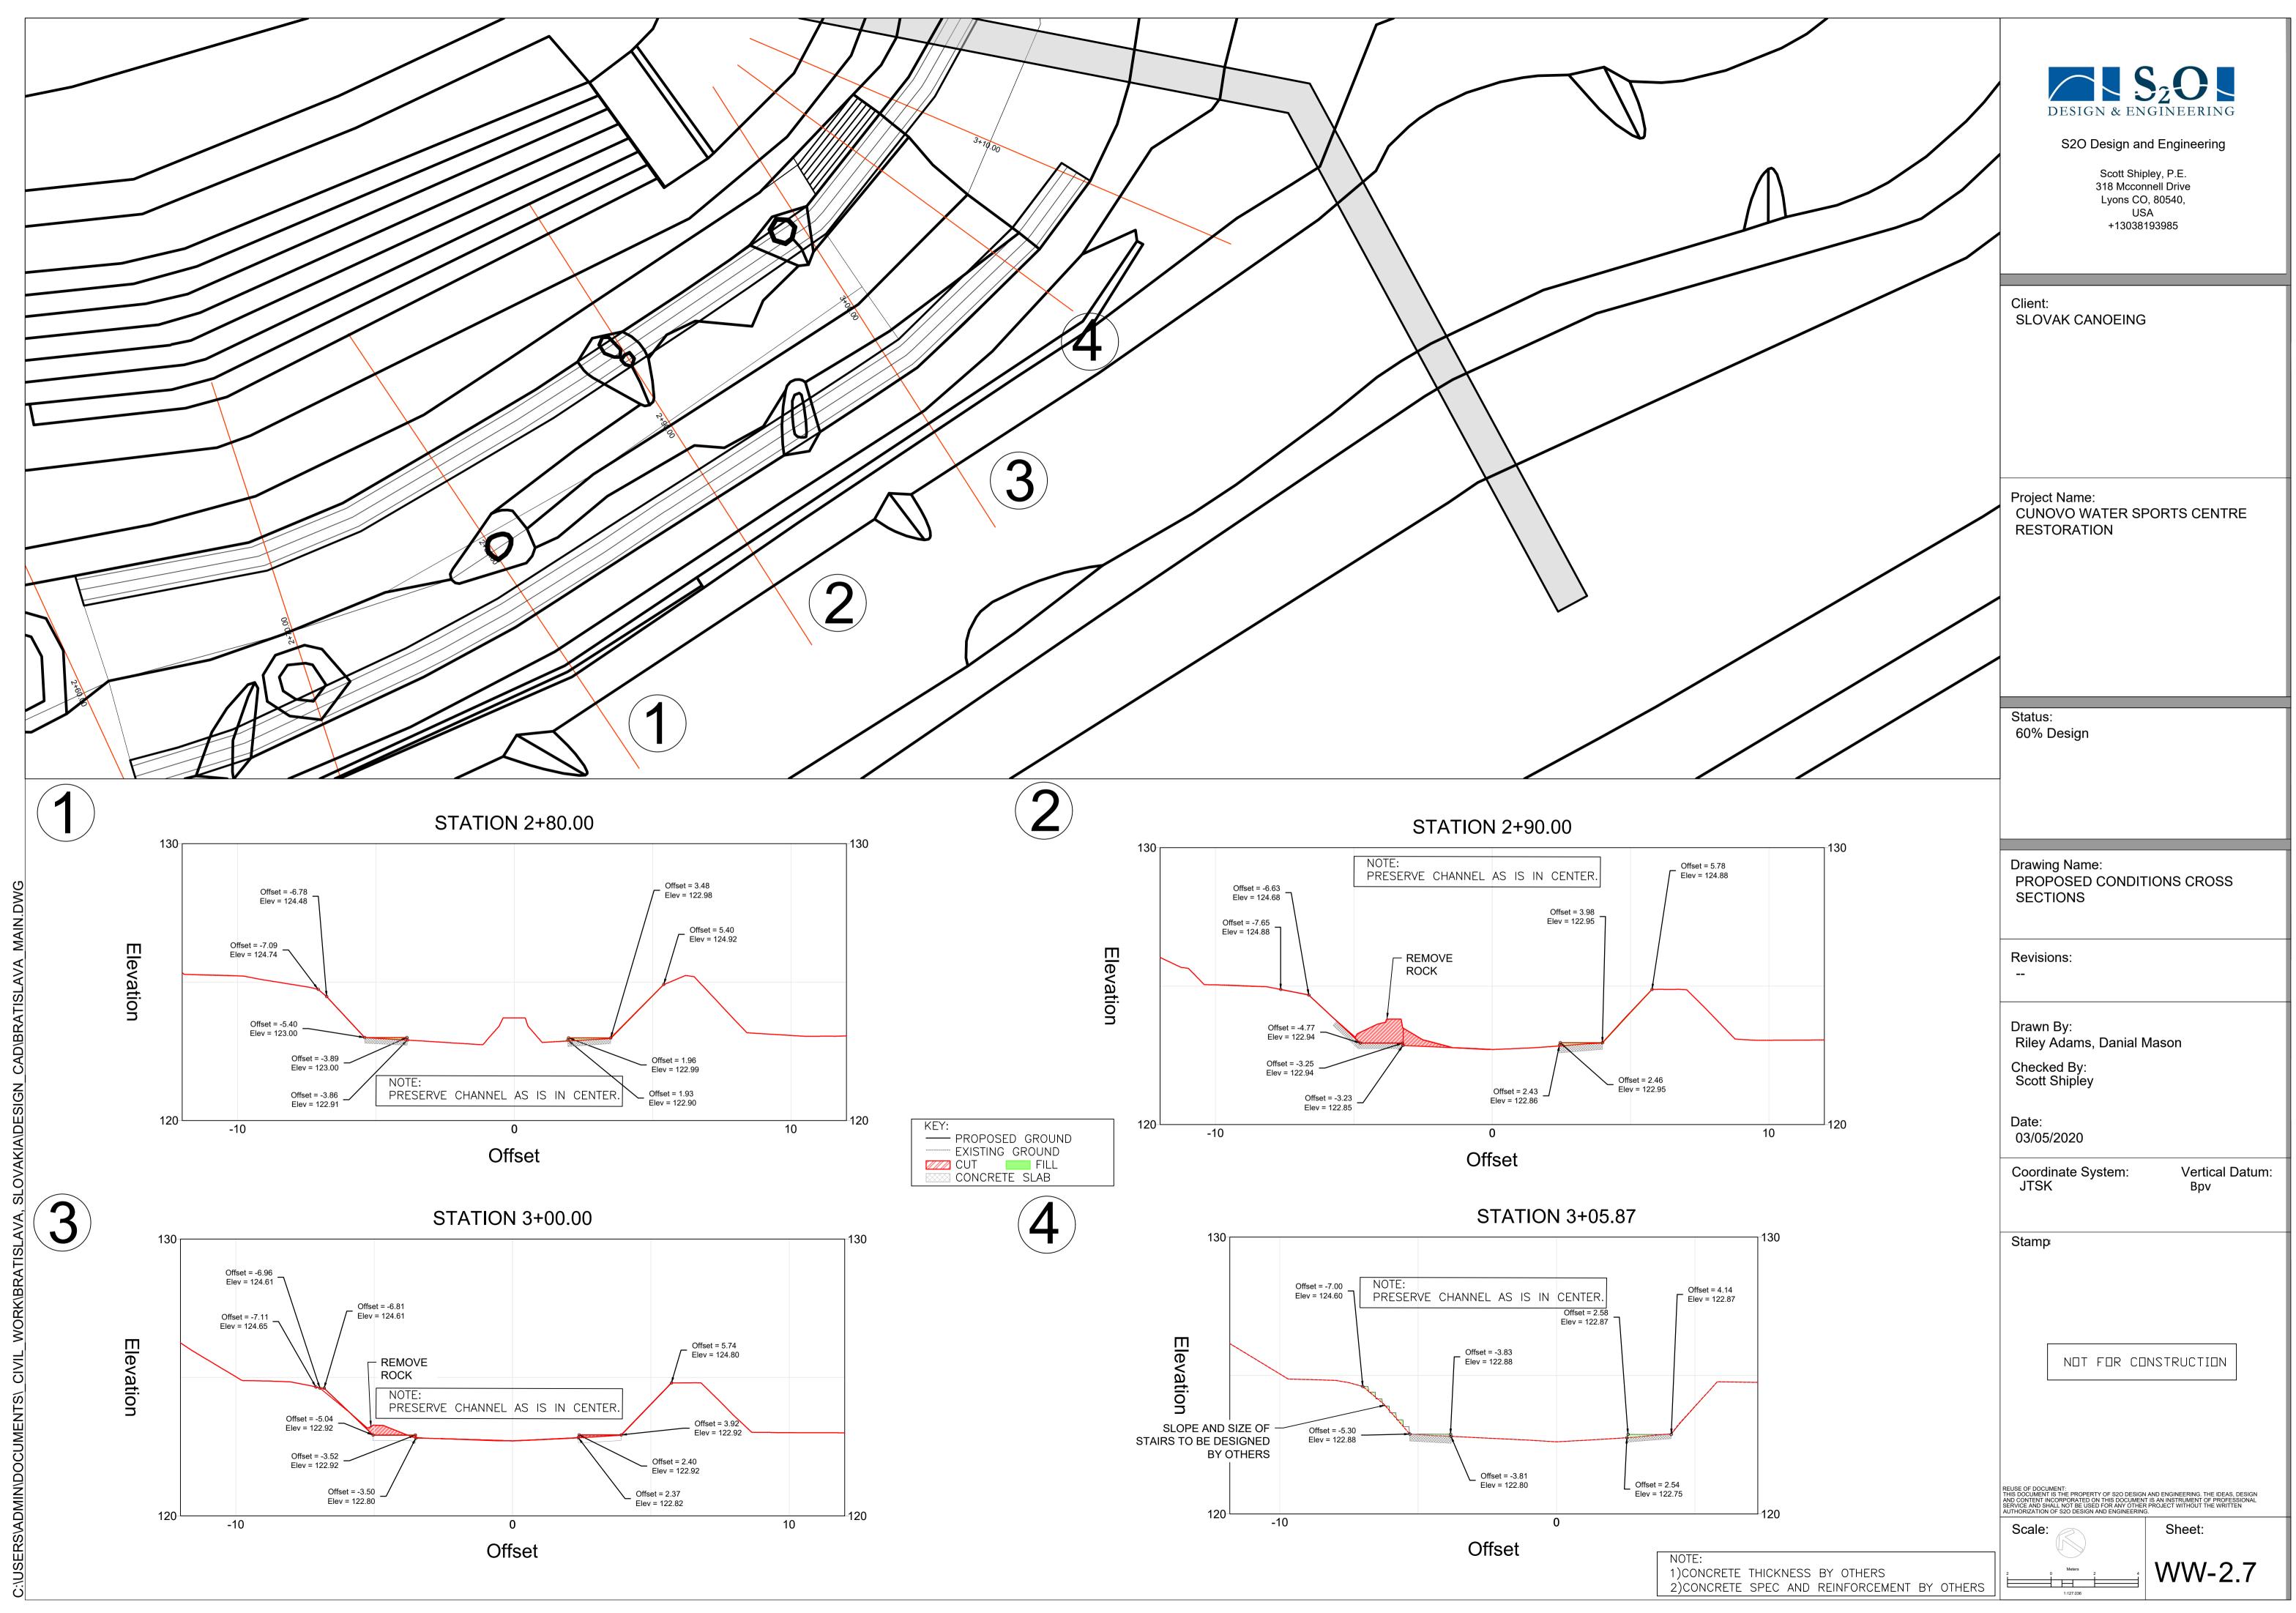


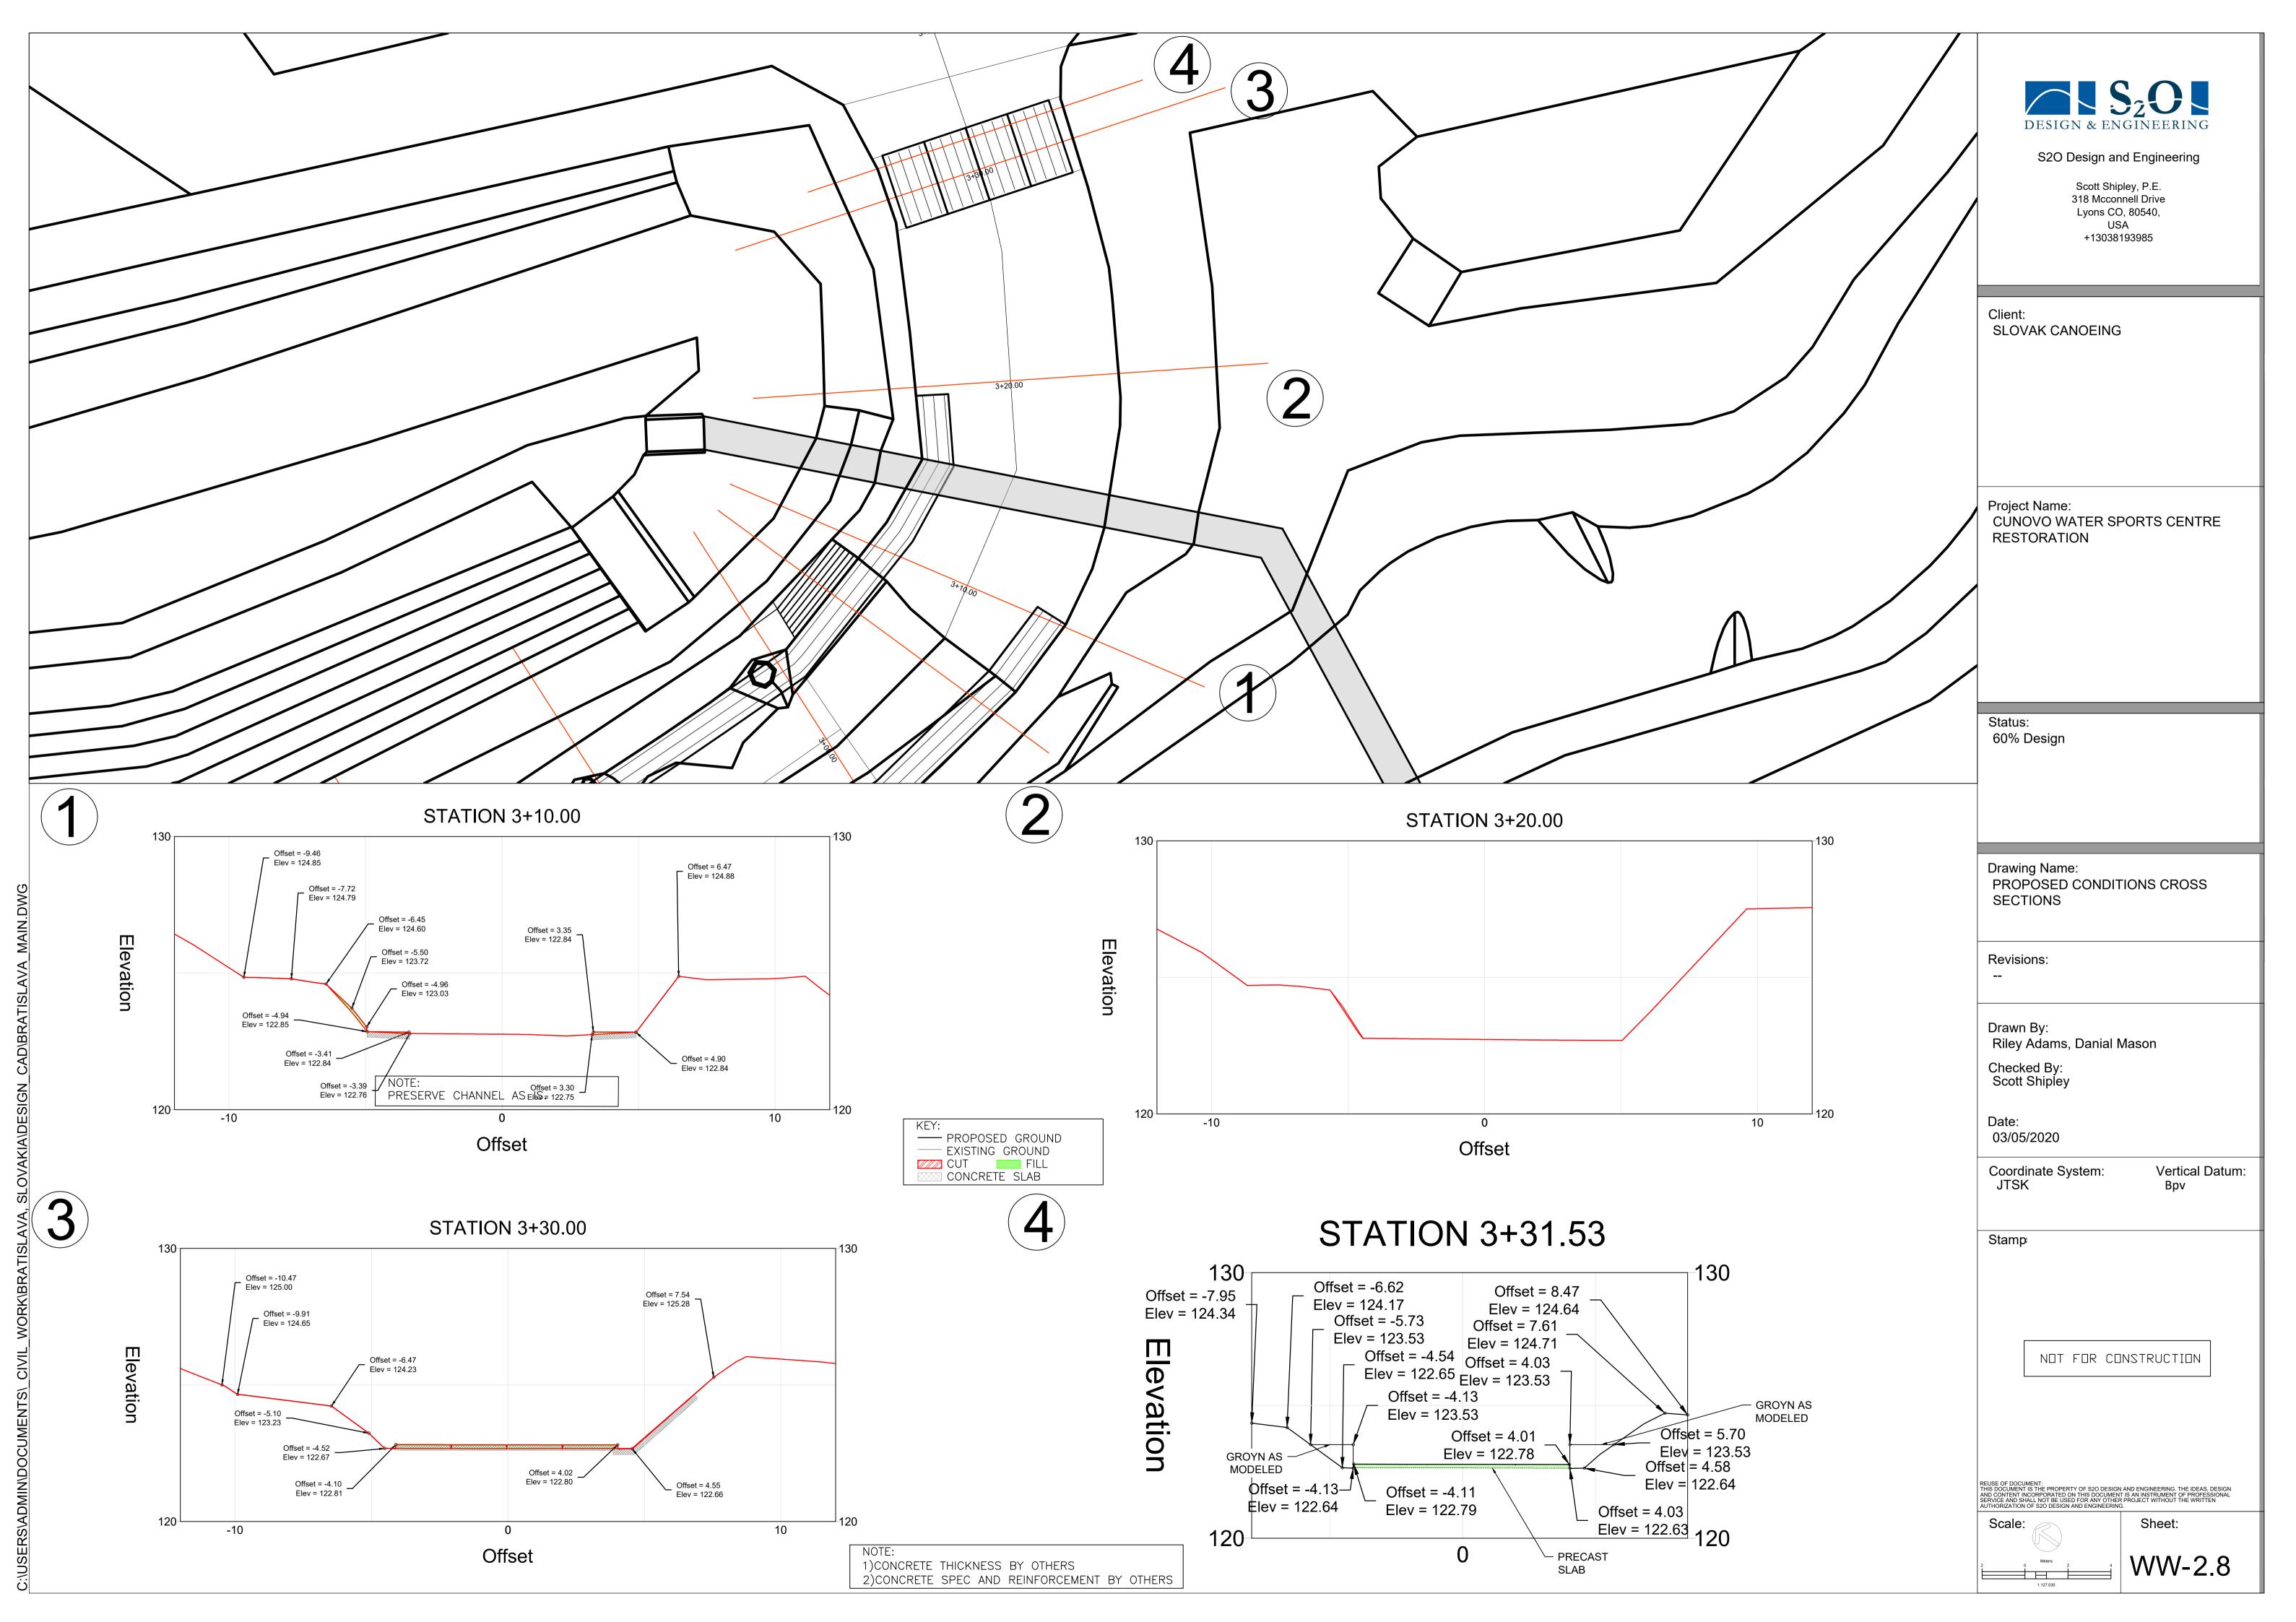





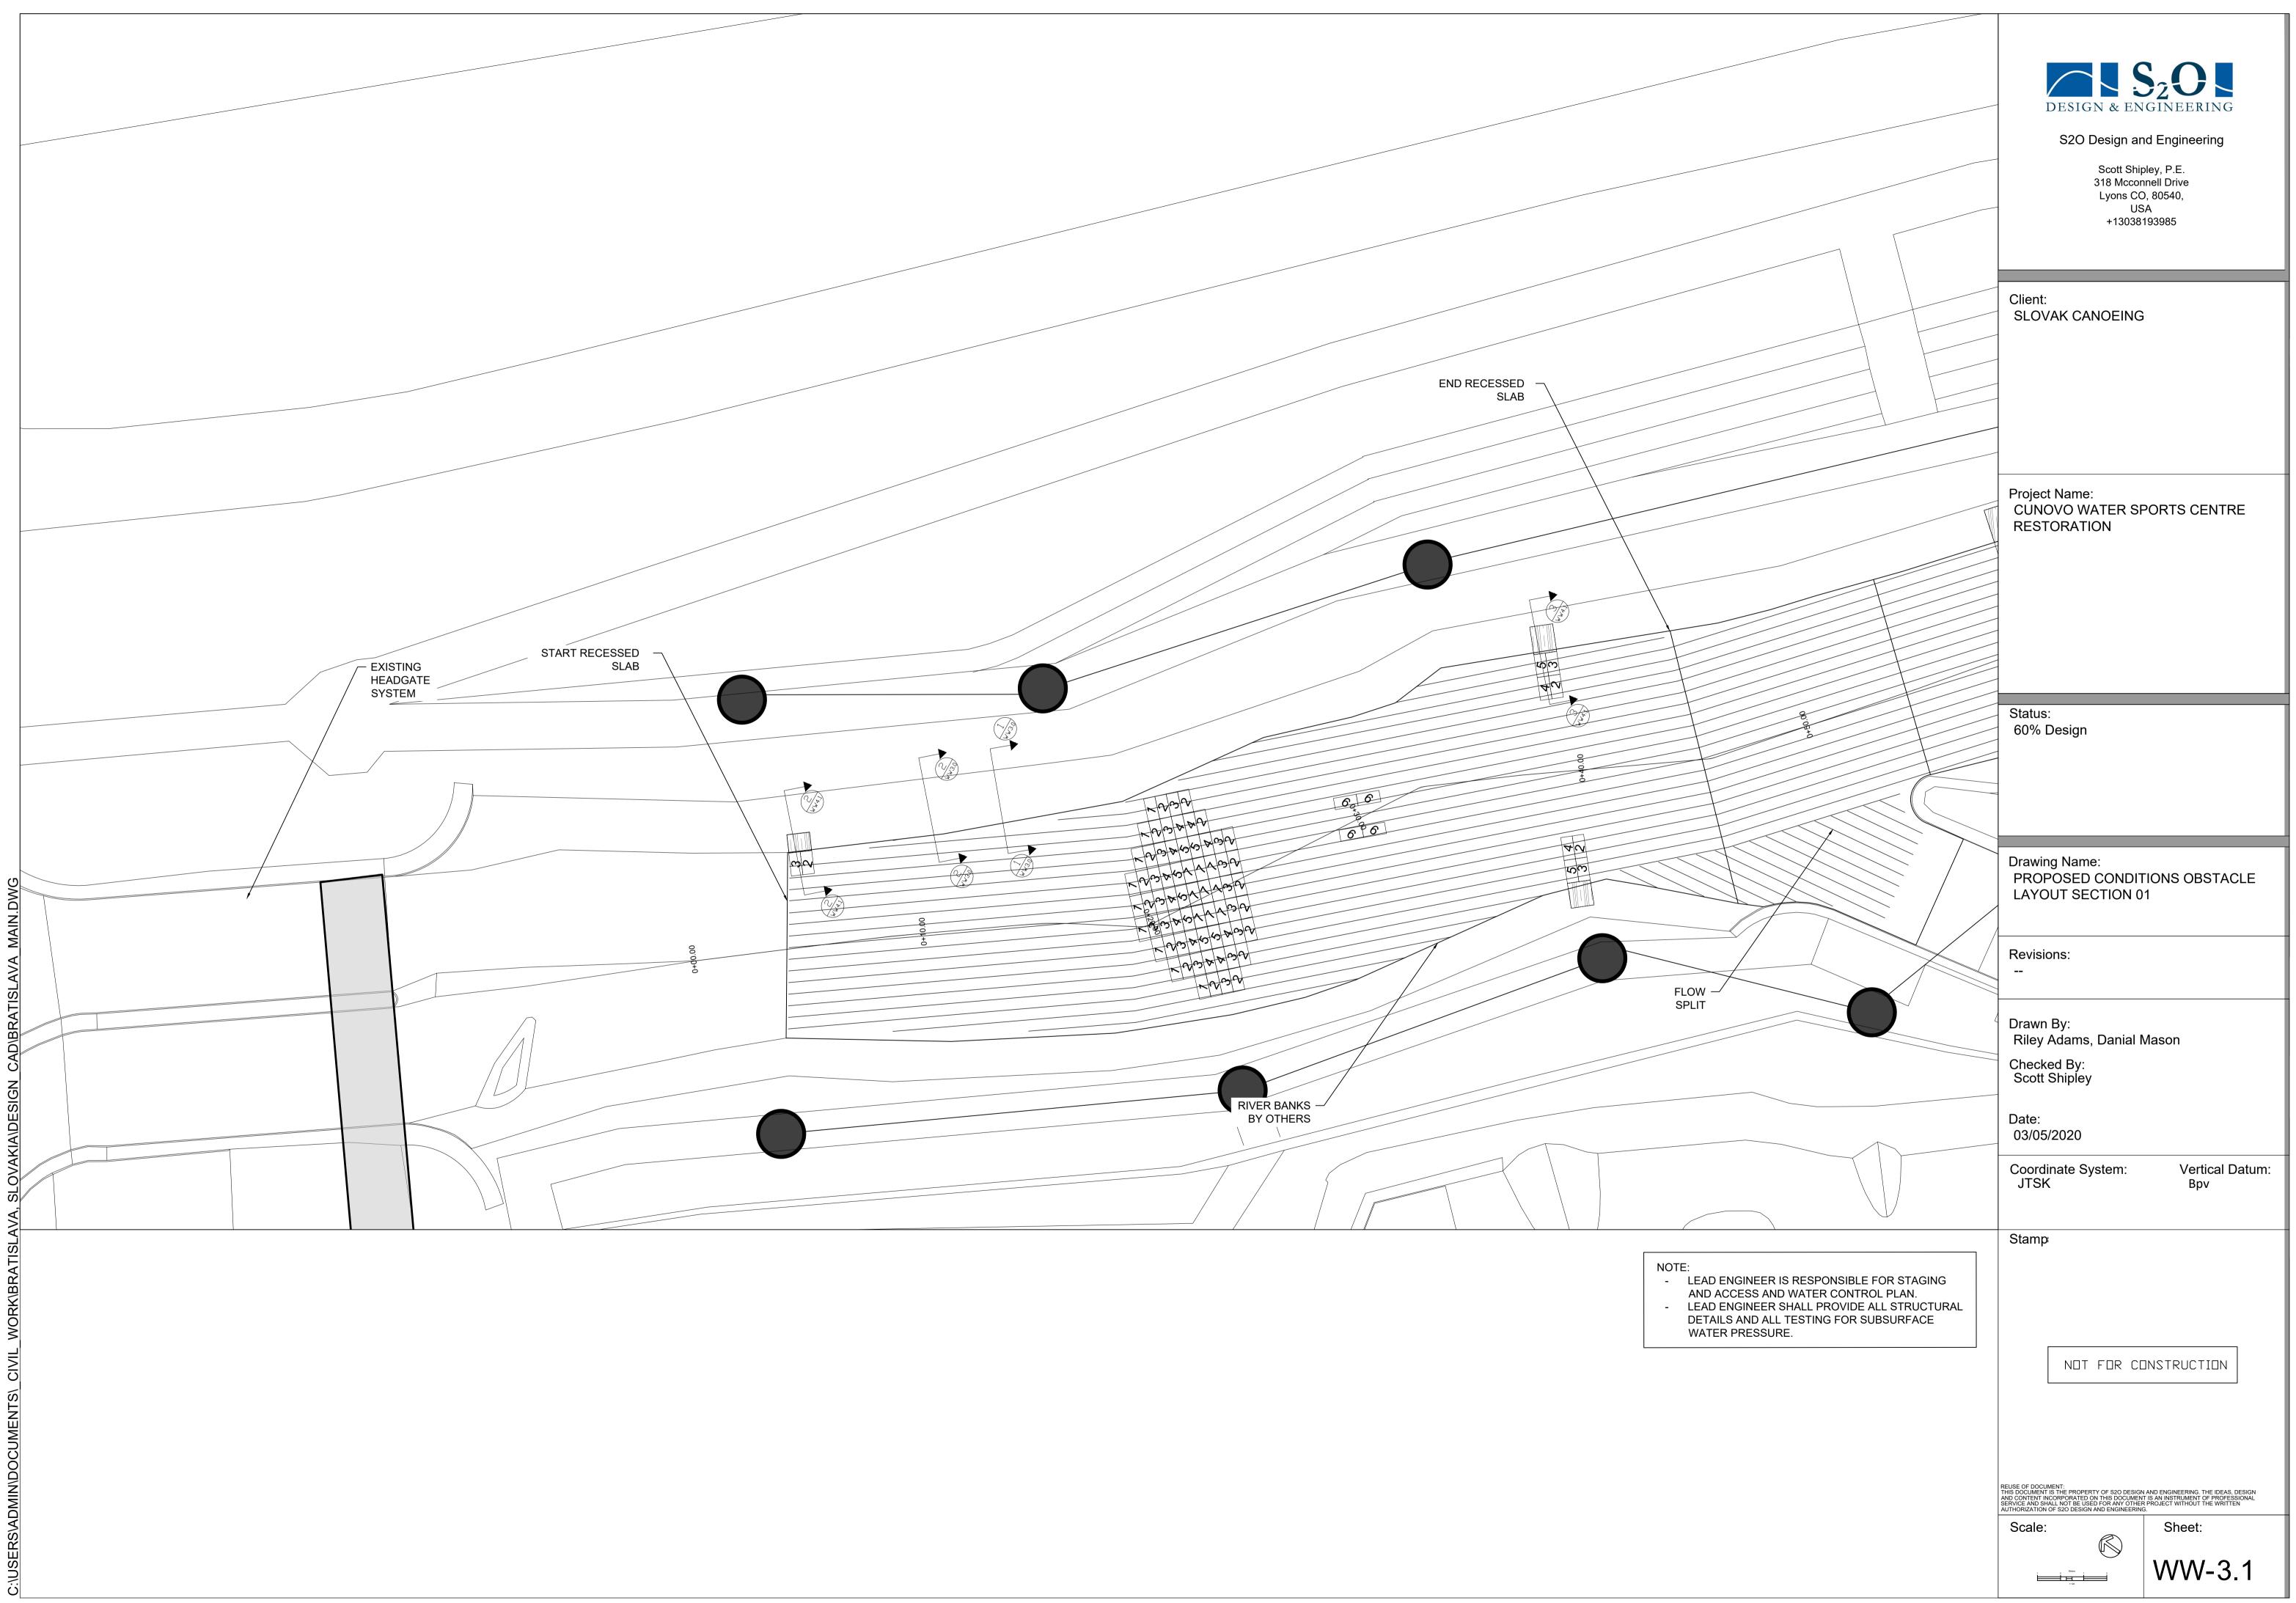


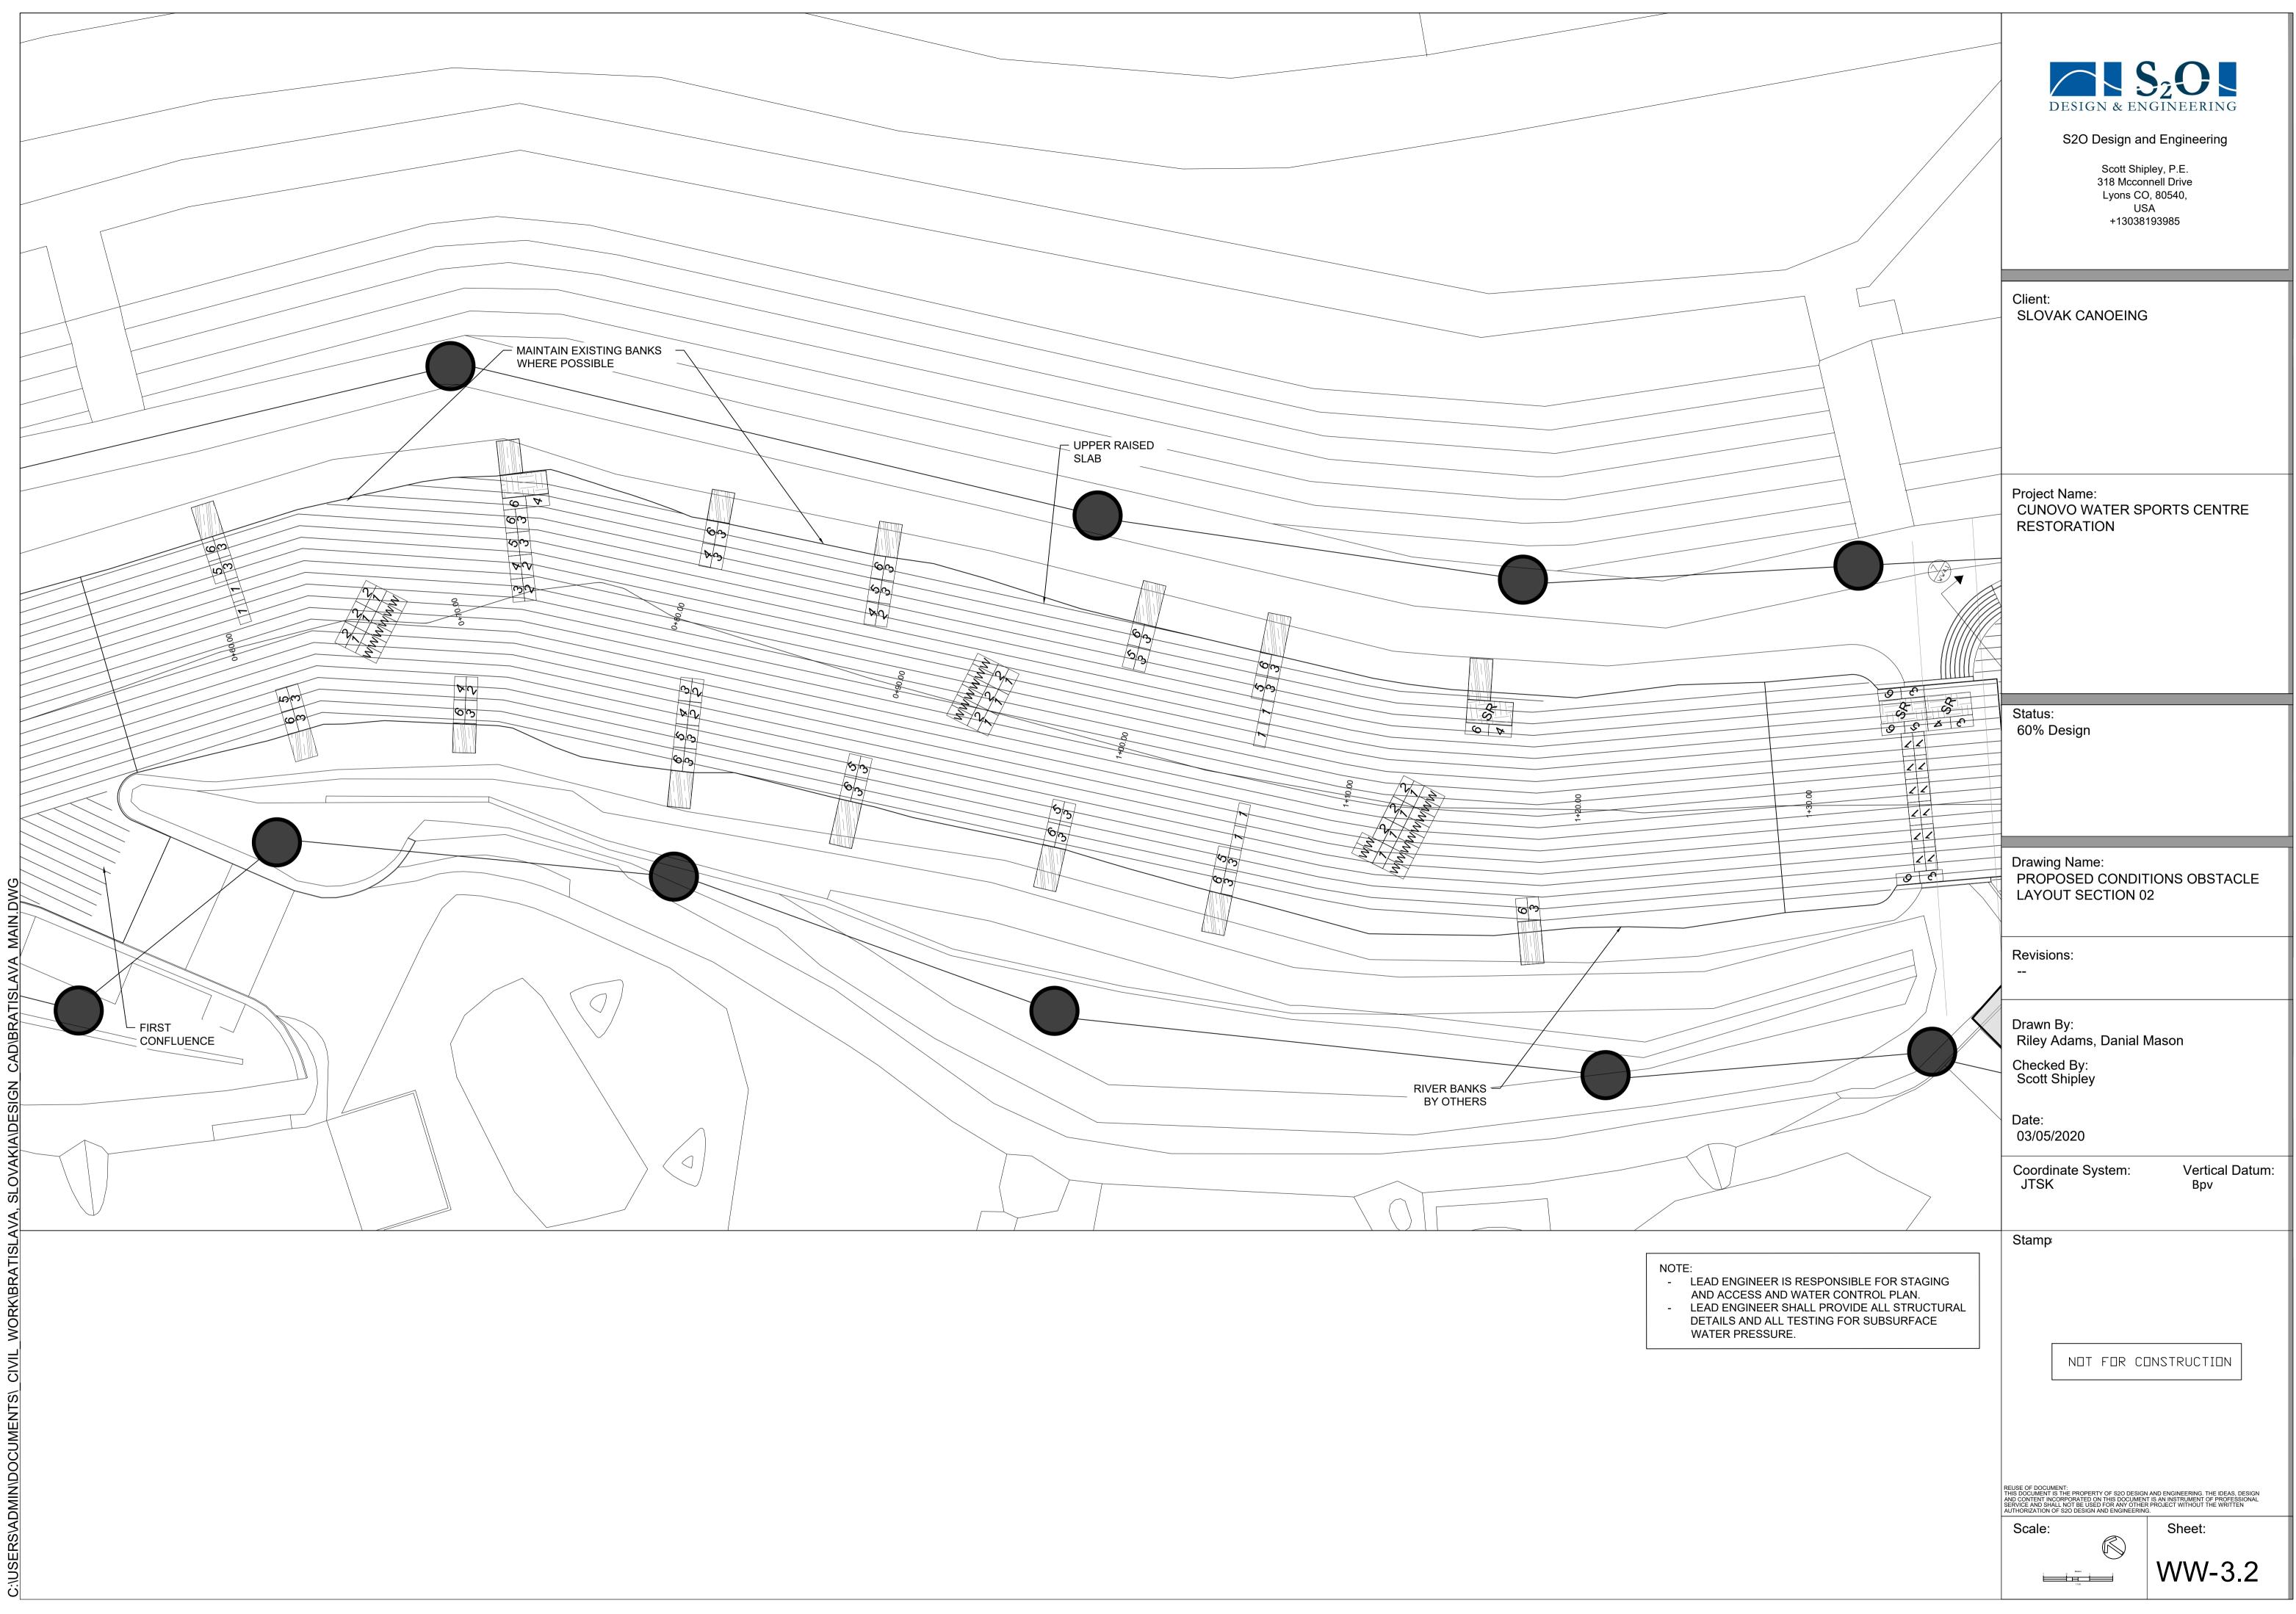


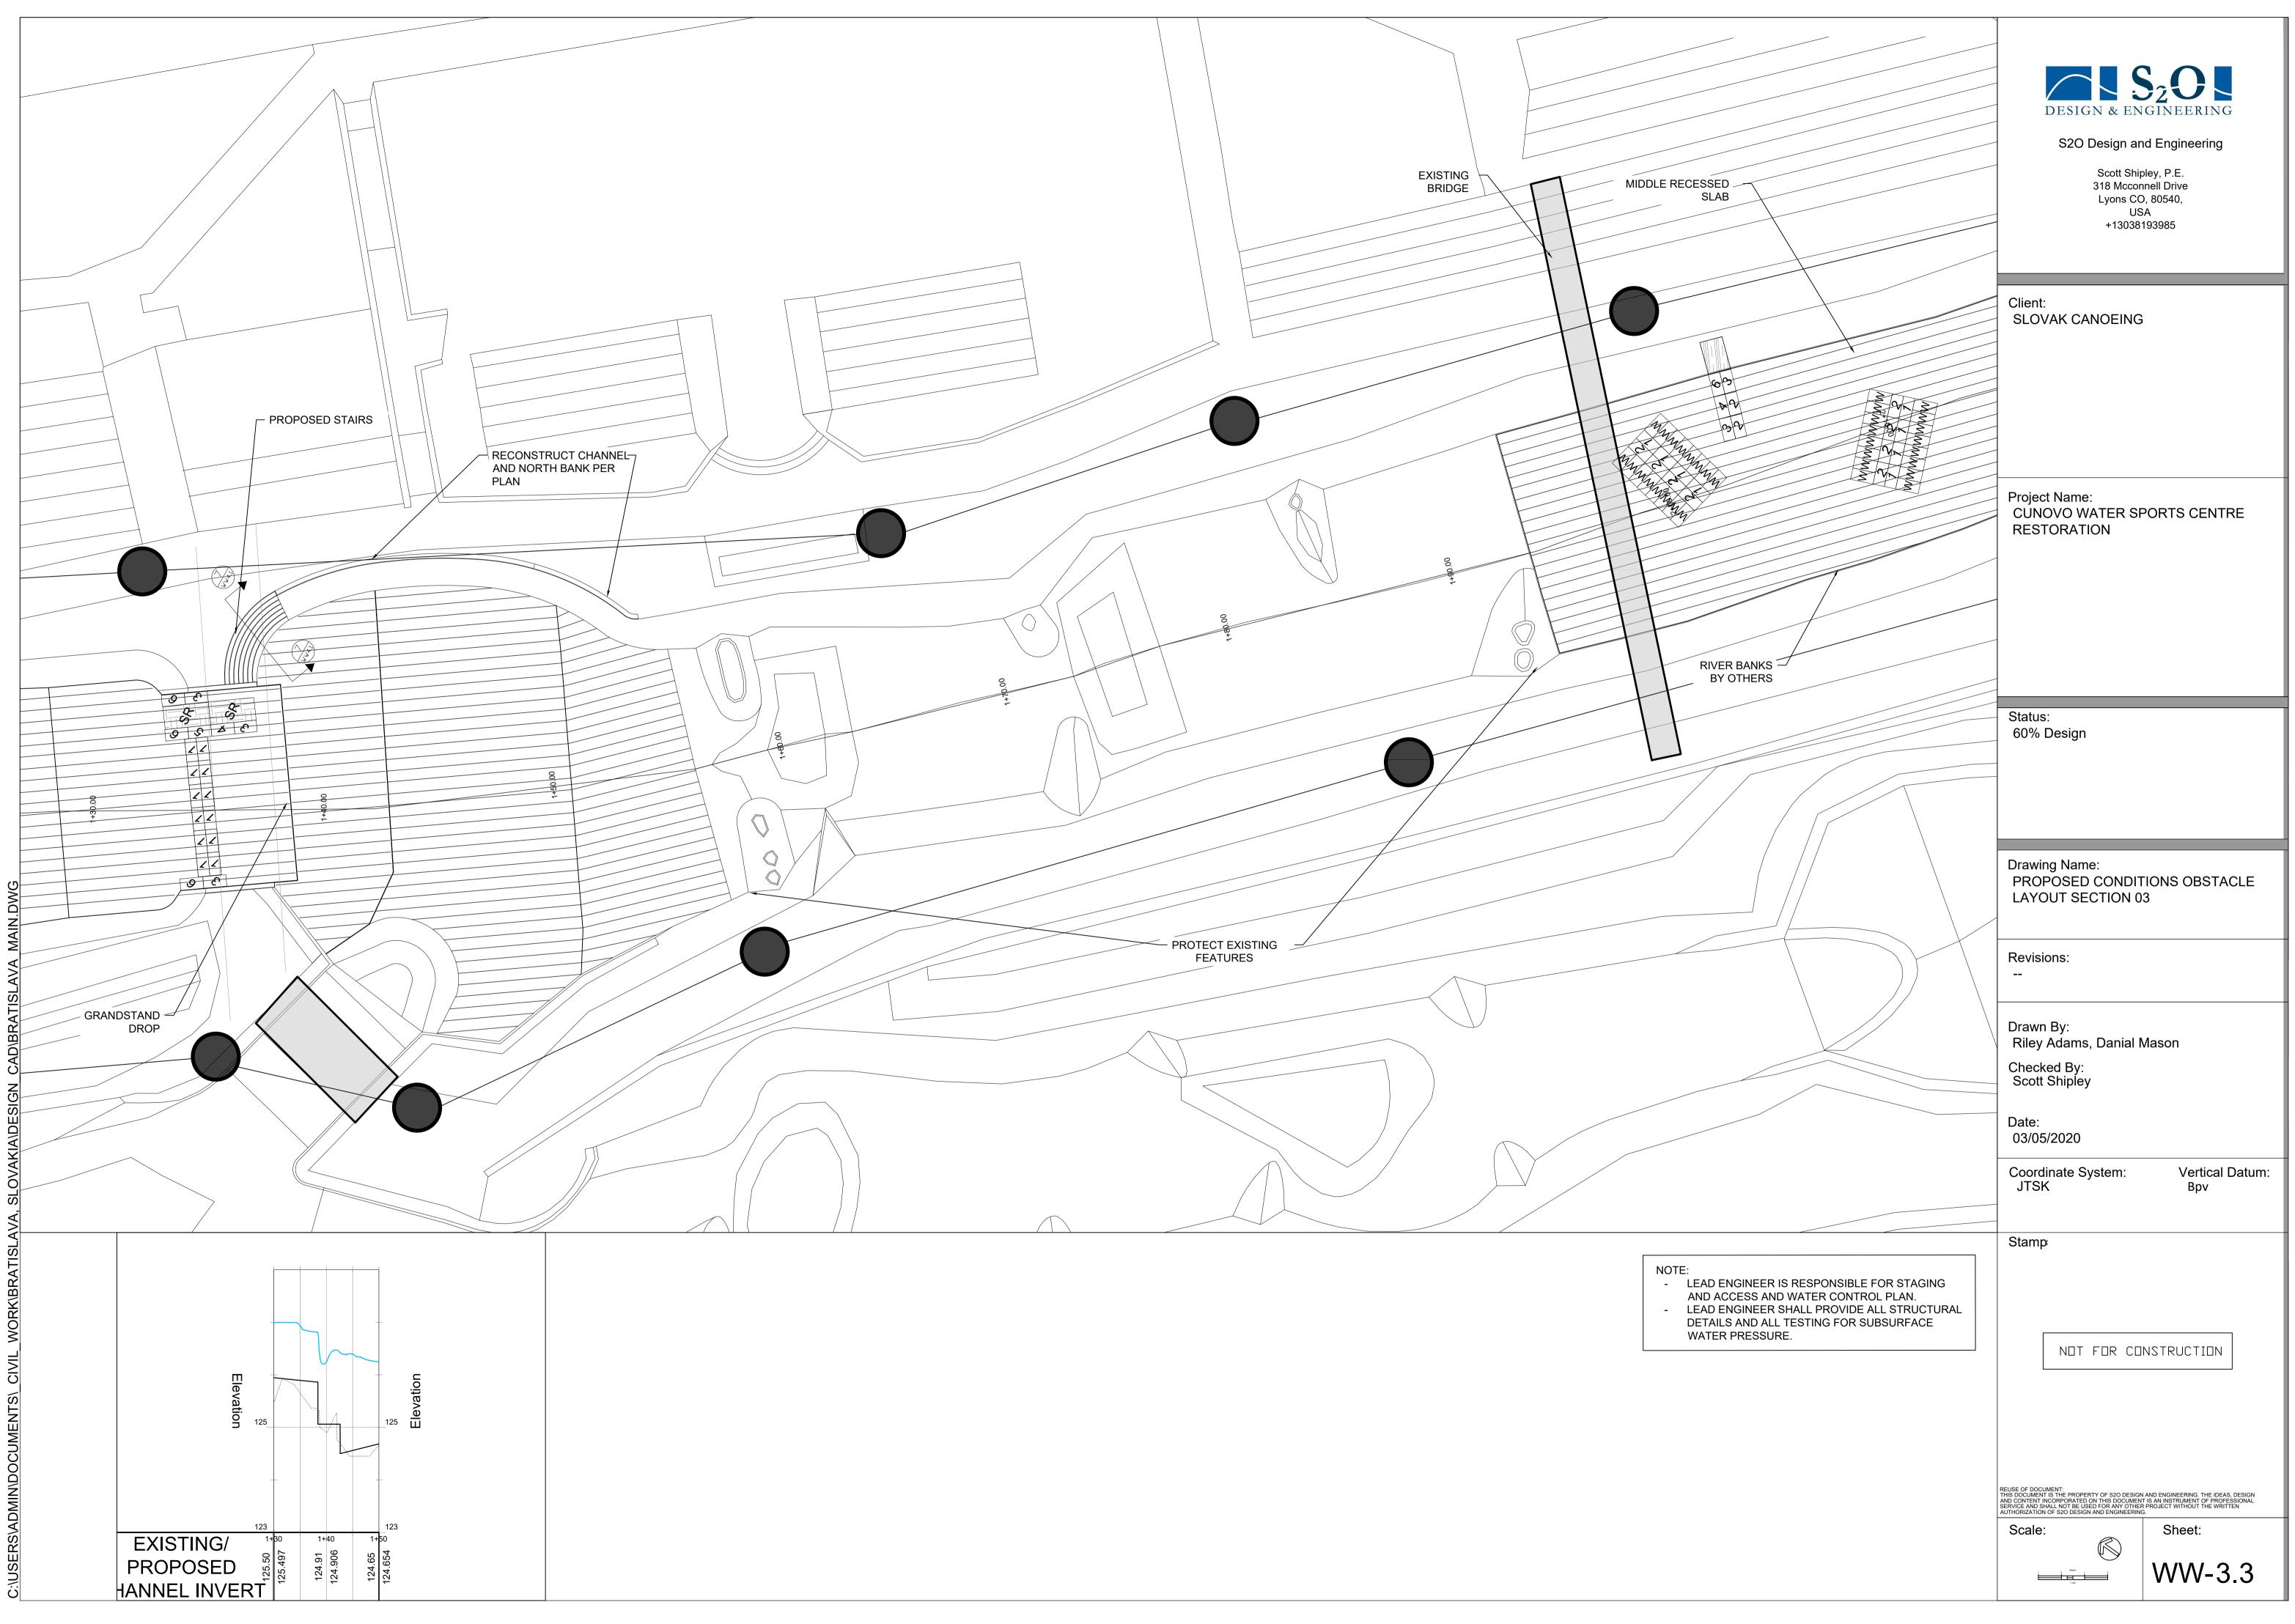


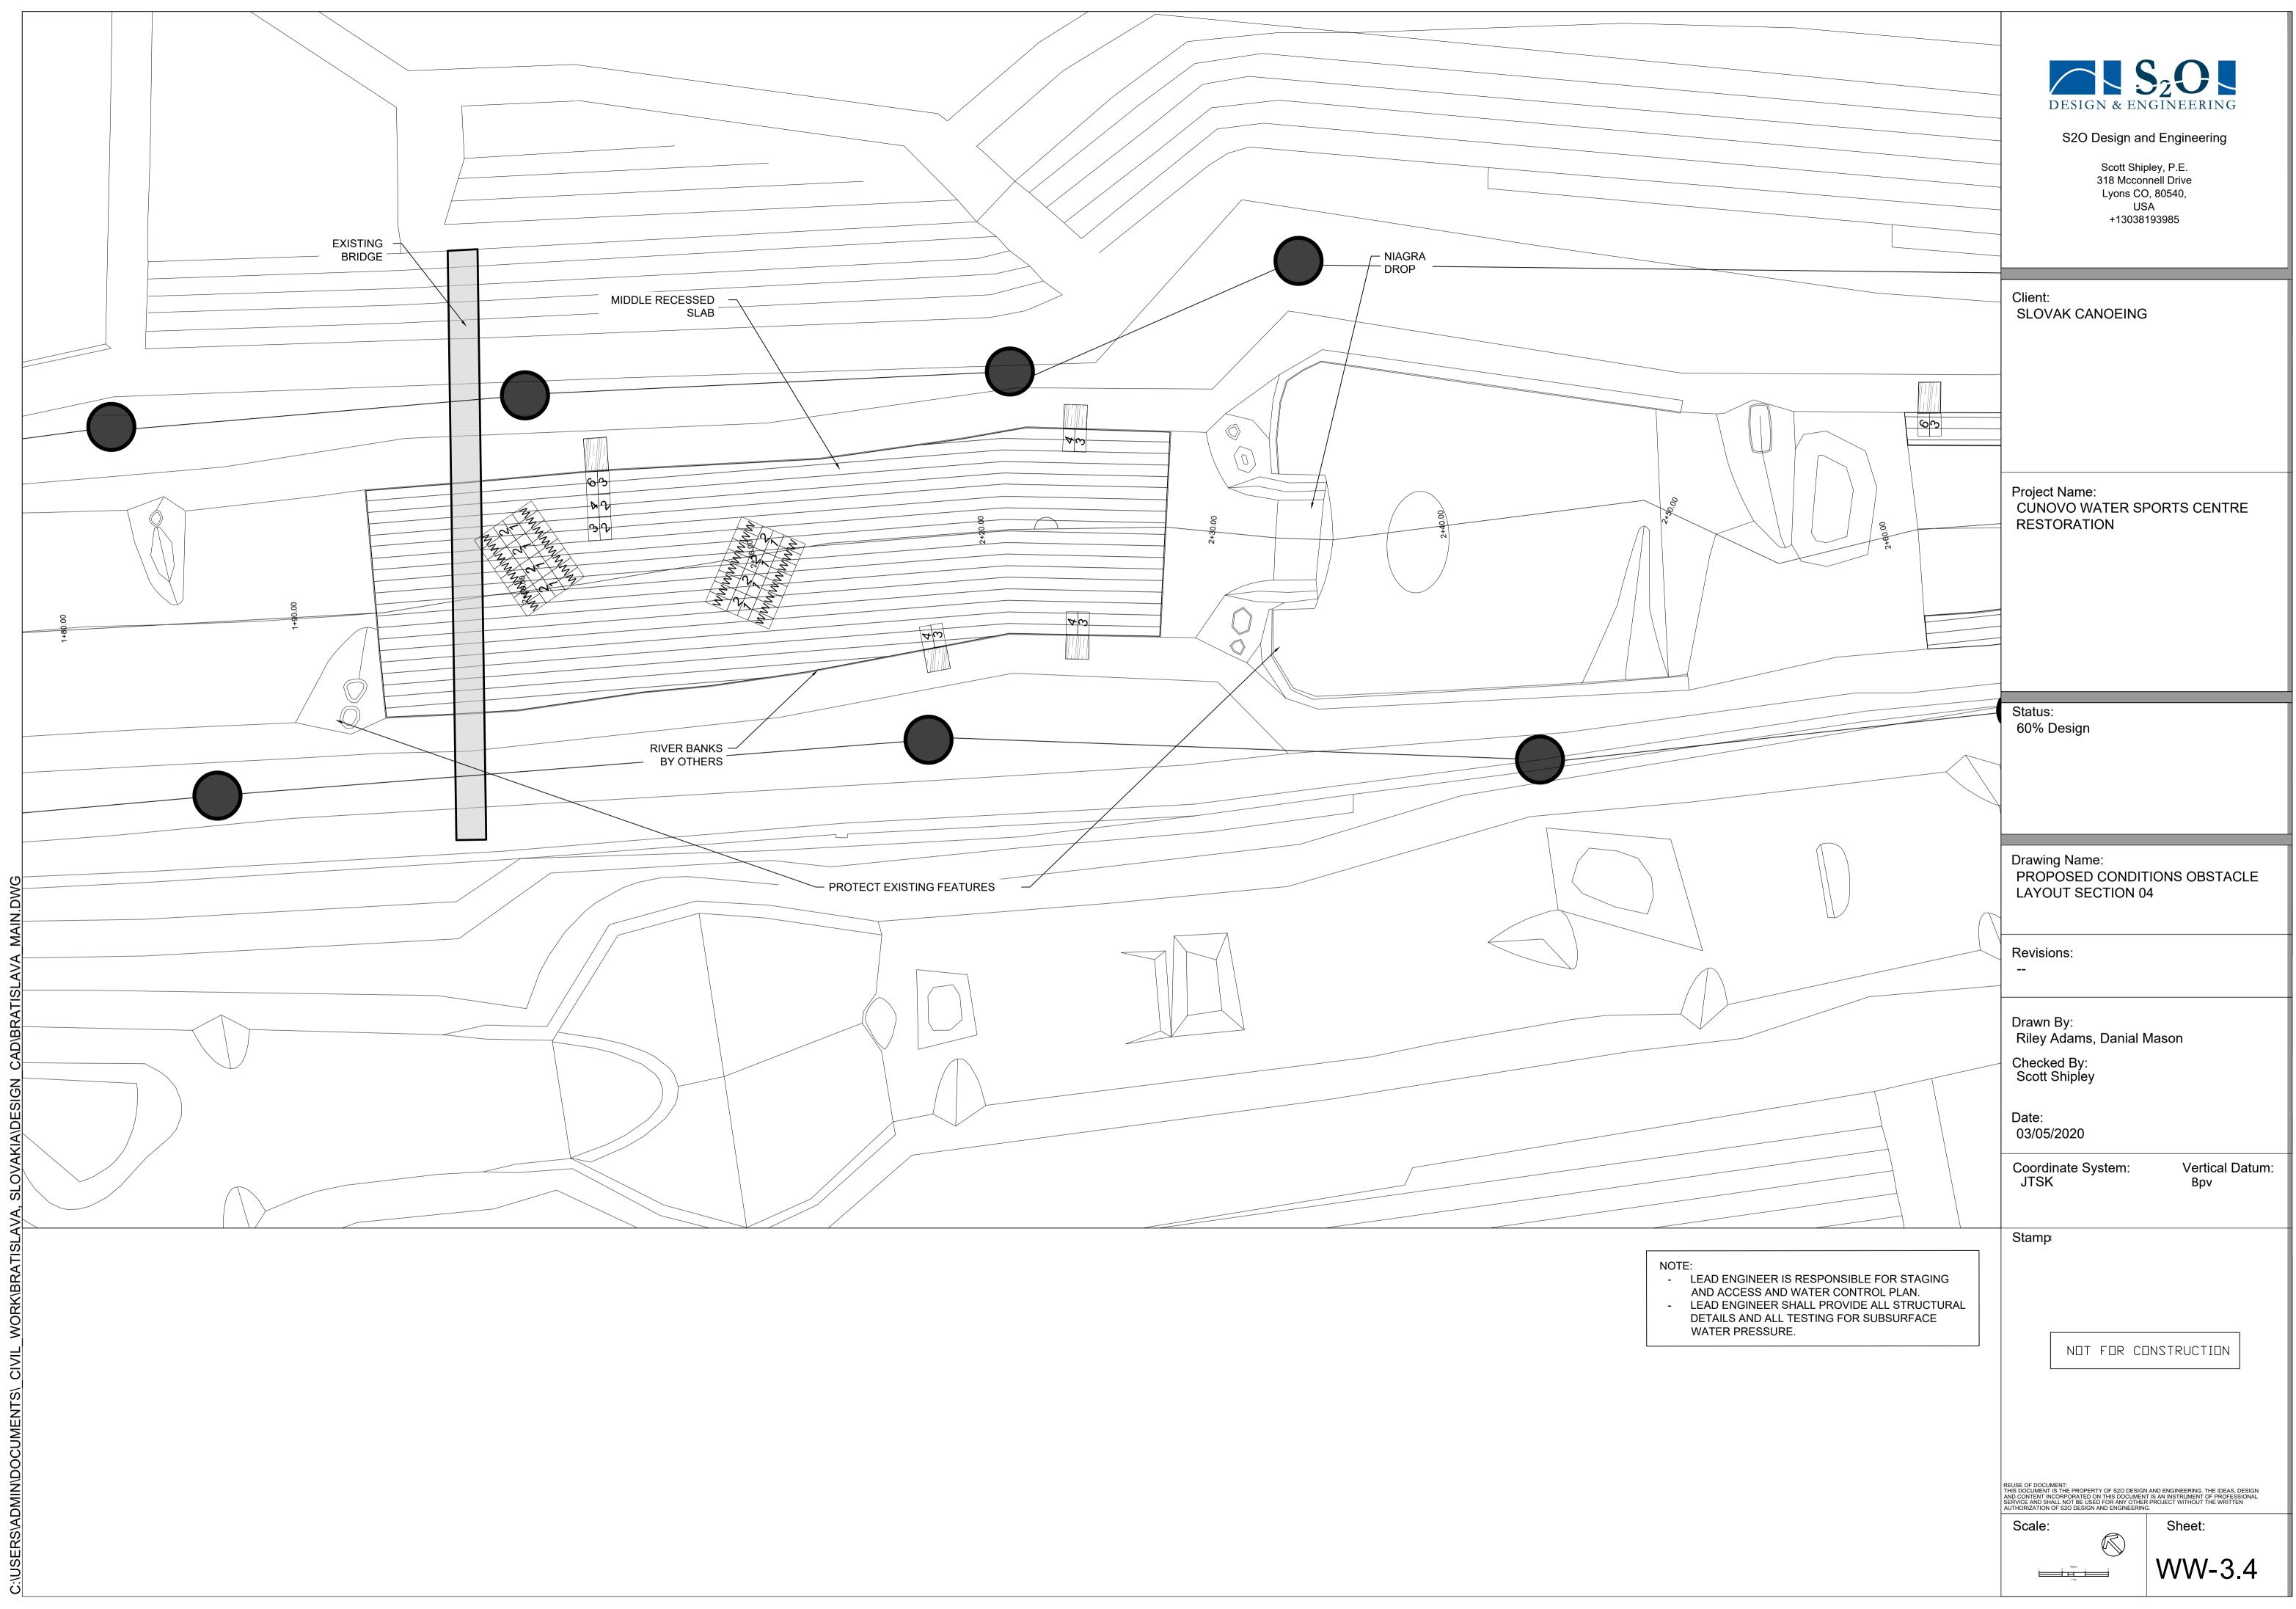


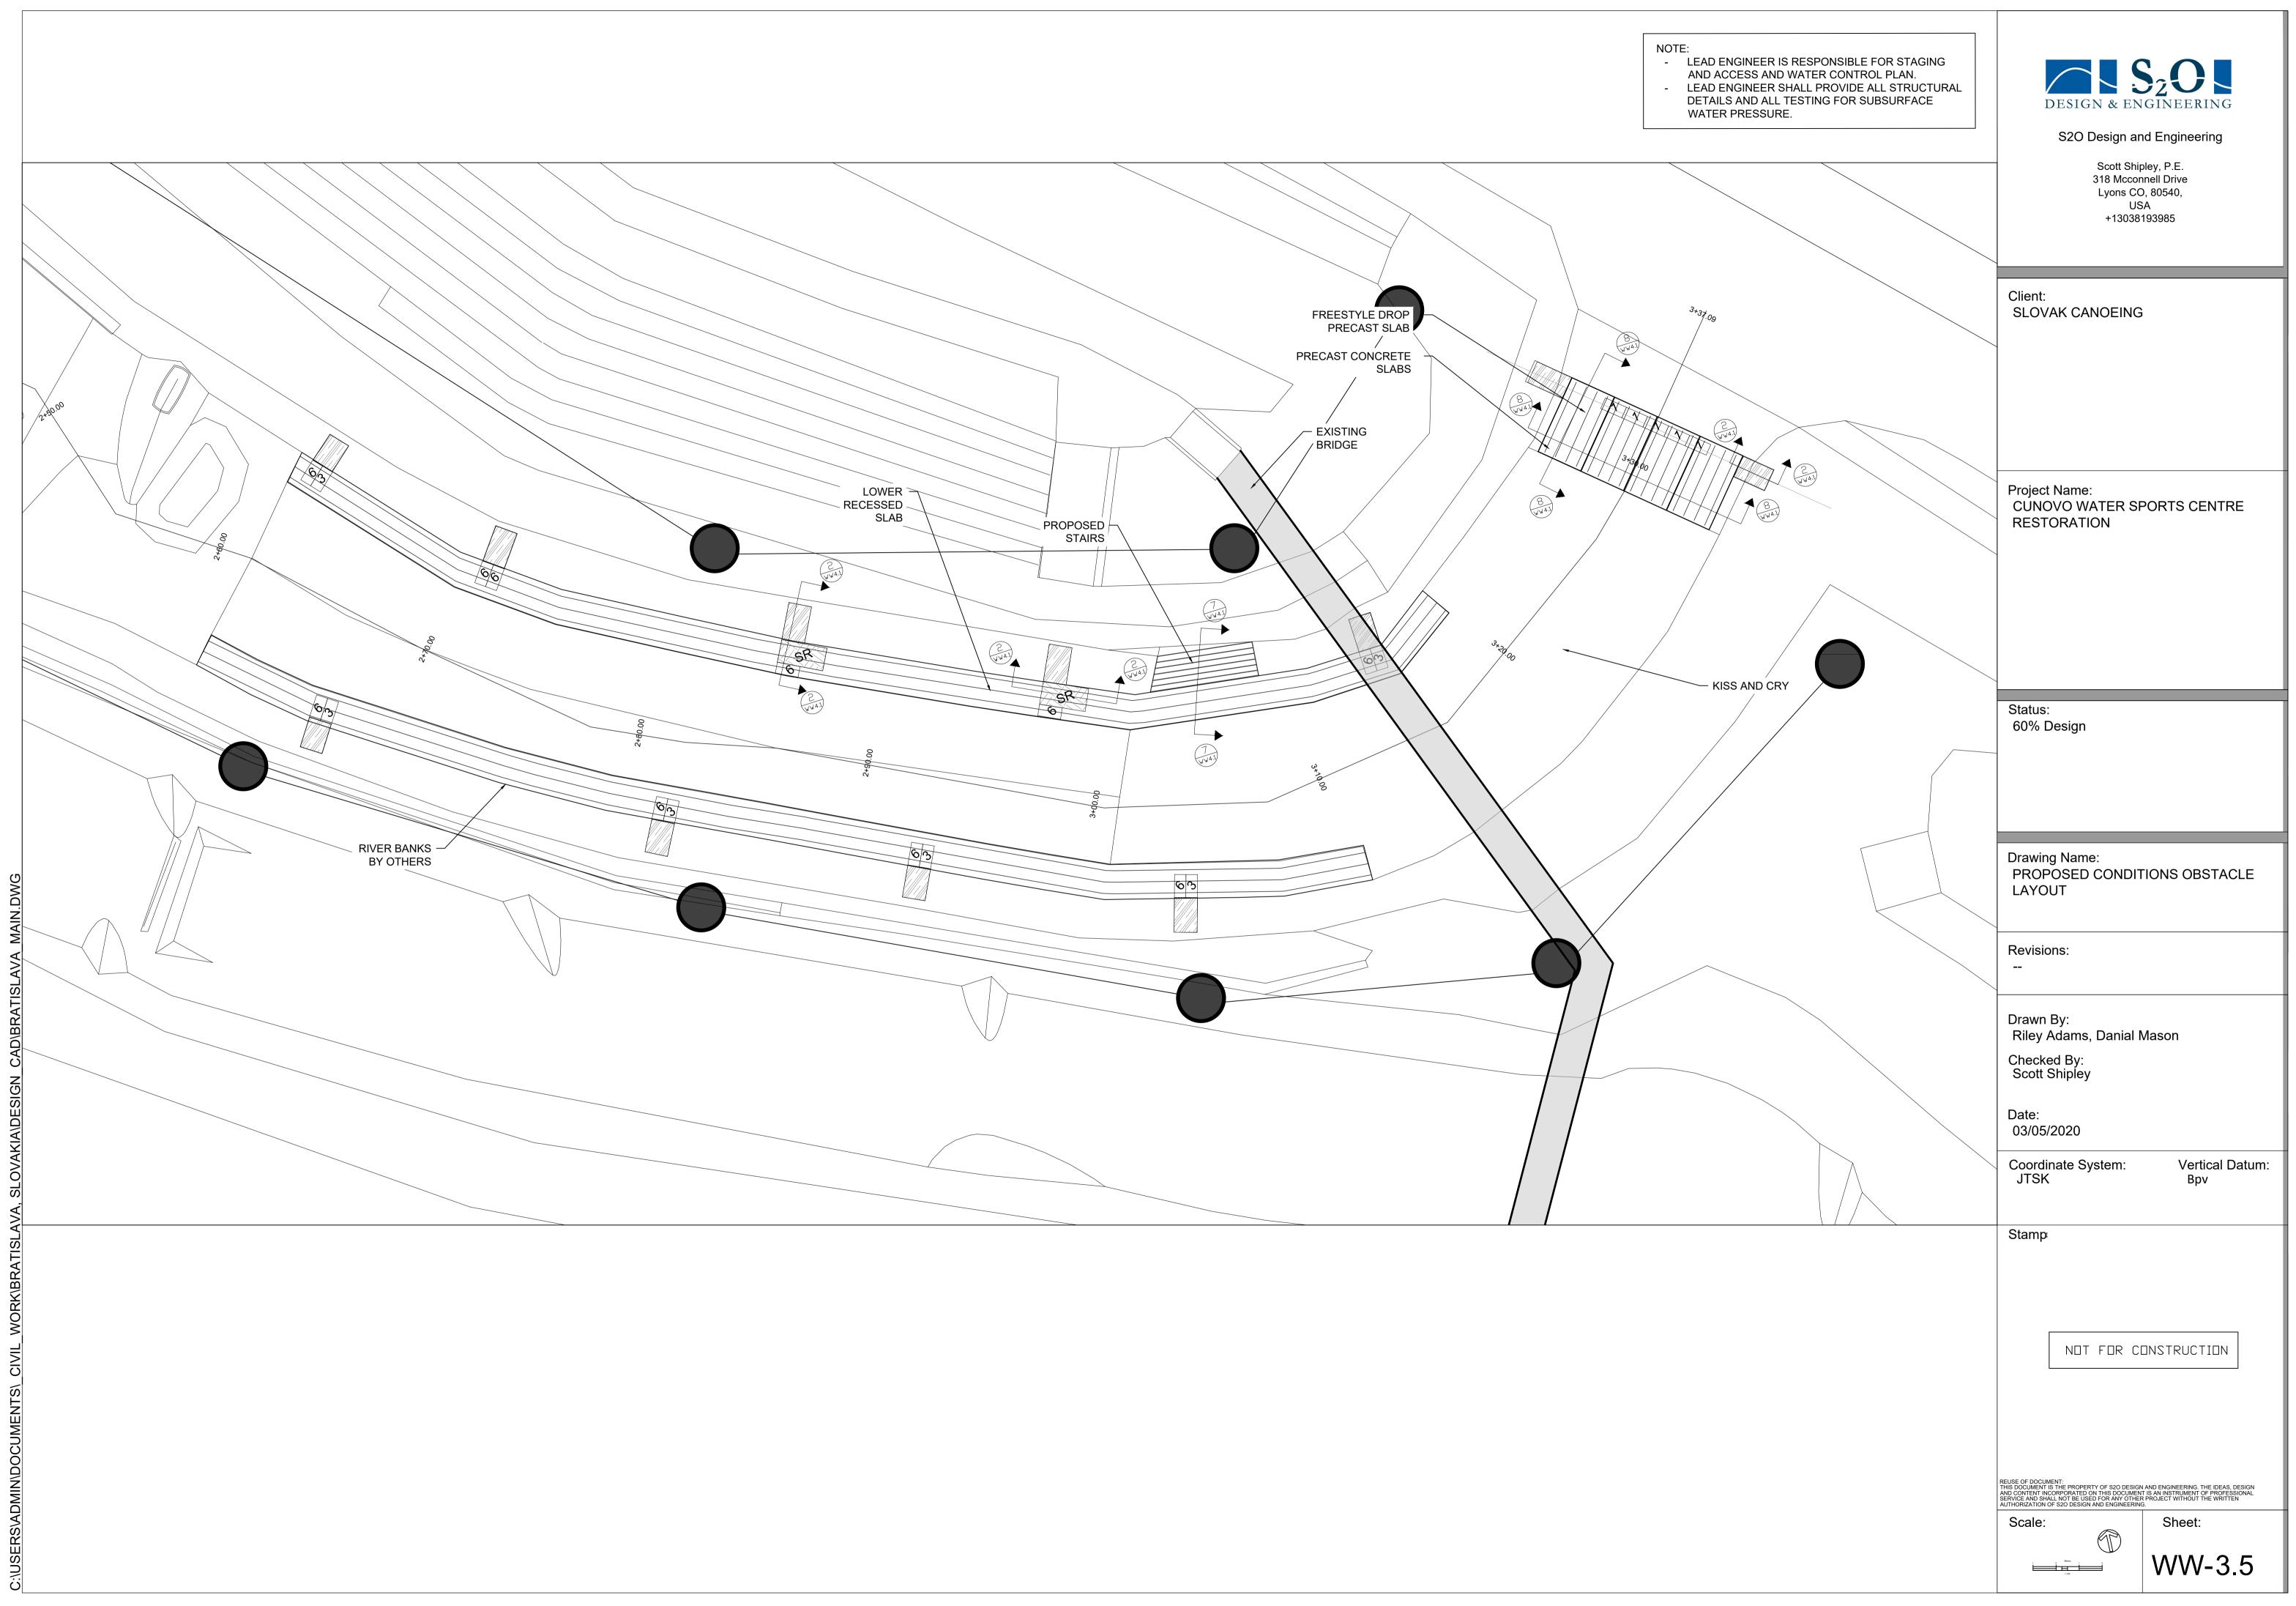

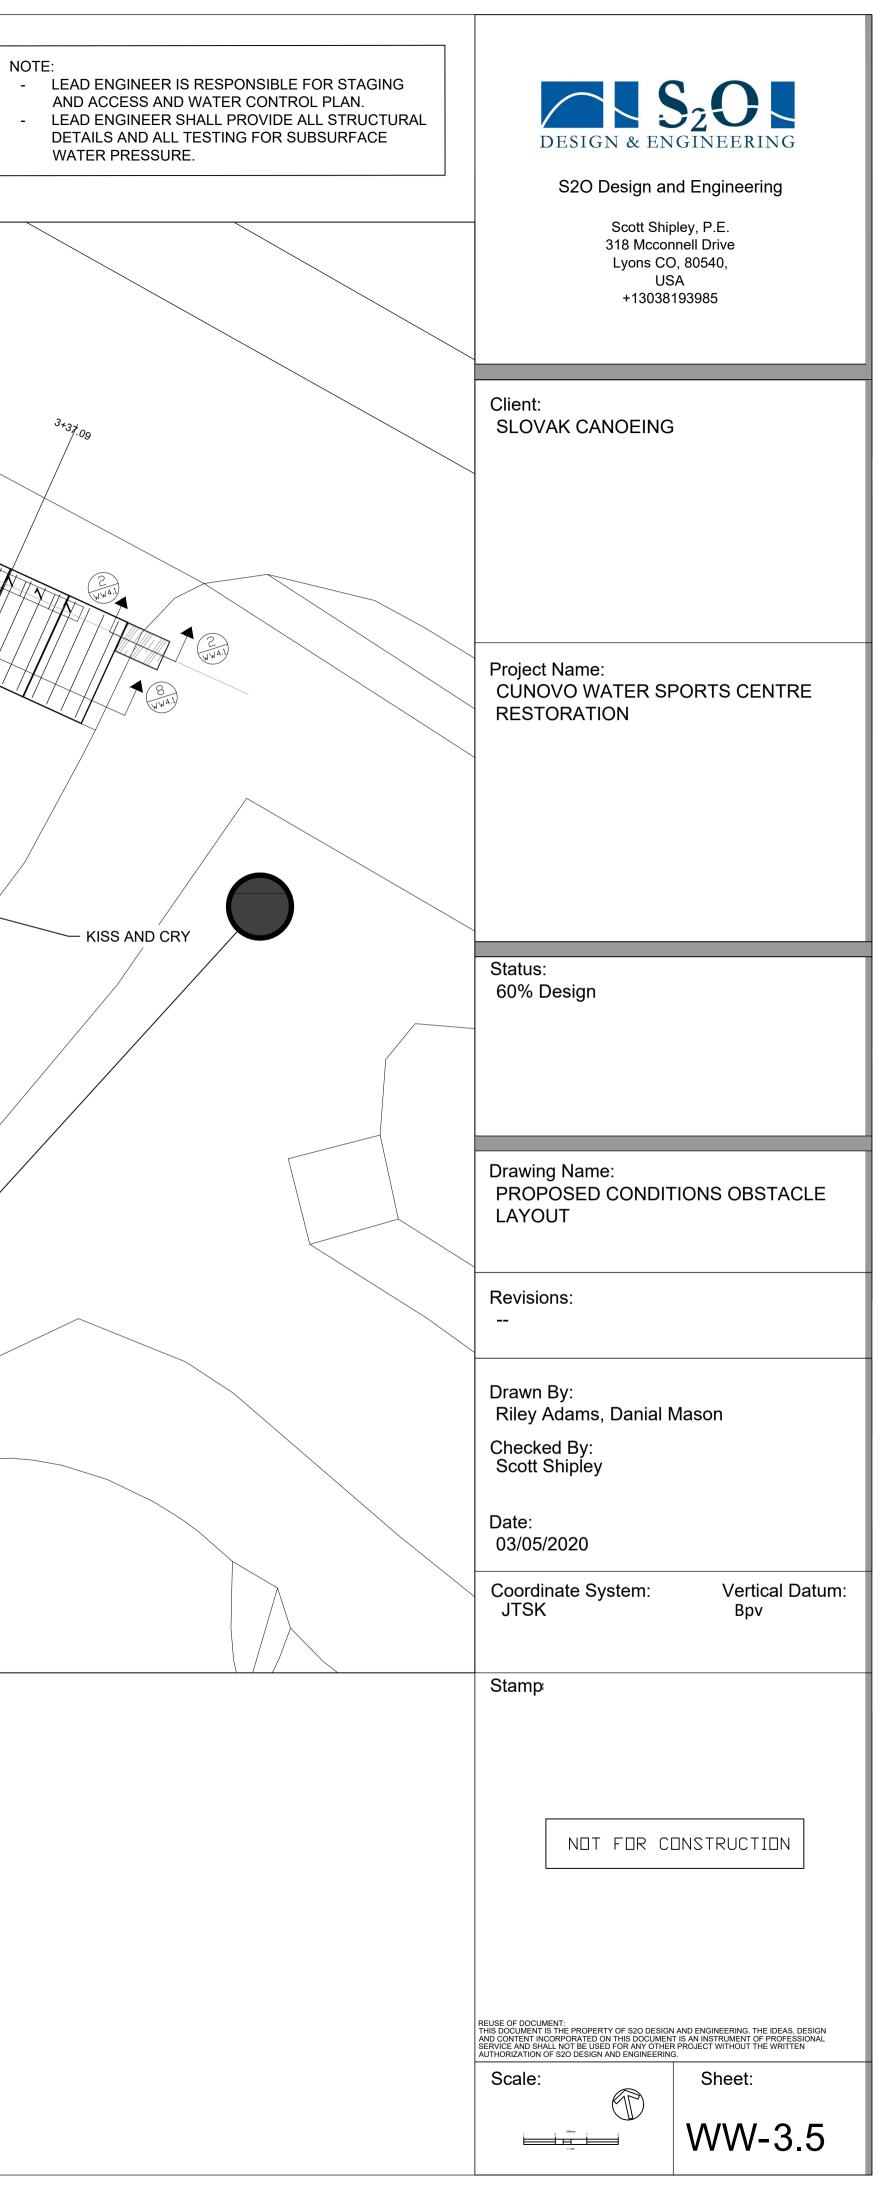

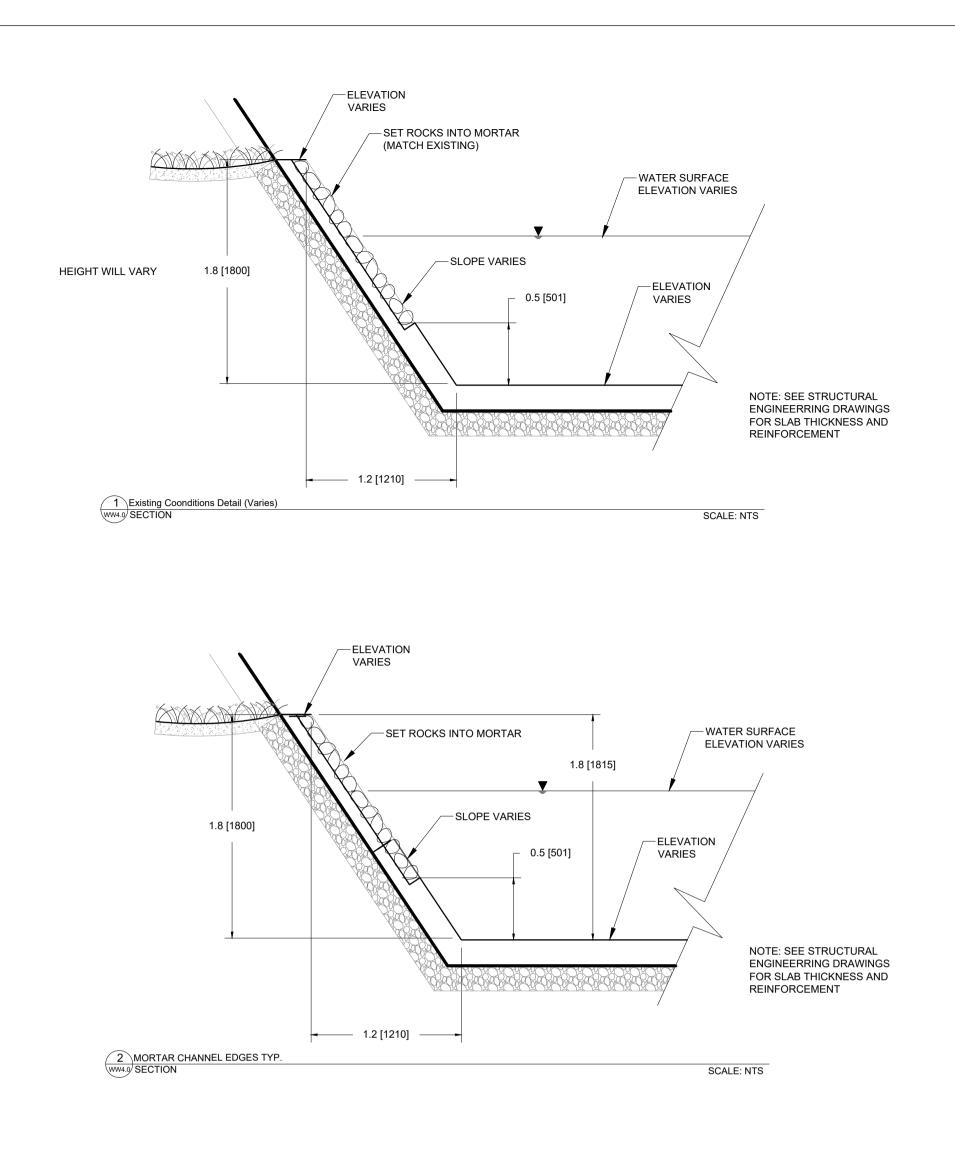

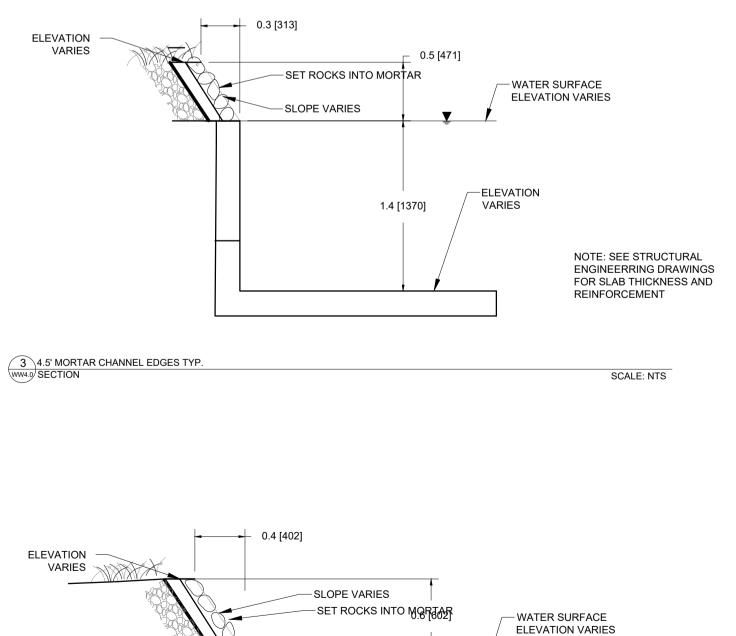

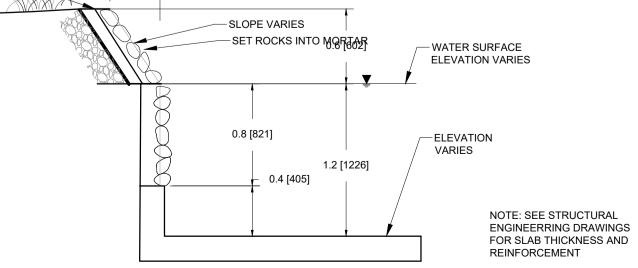

4 VERTICAL MORTAR CHANNEL EDGES TYP.

SCALE: NTS

5 TEMPORARY GROYN DETAIL (See Structural Engineering Drawings)

SCALE: NTS

SCALE: NTS

SCALE: NTS


6 WATER CONTROL STRUCTURE DETAIL (See Structural Engineering Drawings)

7 DEWATERING WELLS DETAIL (See Structural Engineering Drawings)


8 PRECAST SLABS FOR FREESTLYLE FEATURE (See Structural Engineering Drawings)

SCALE: NTS


NOTE: REFER TO STRUCTURAL ENGINEERING PLANS FOR ANYTHING BELOW THE SURFACE

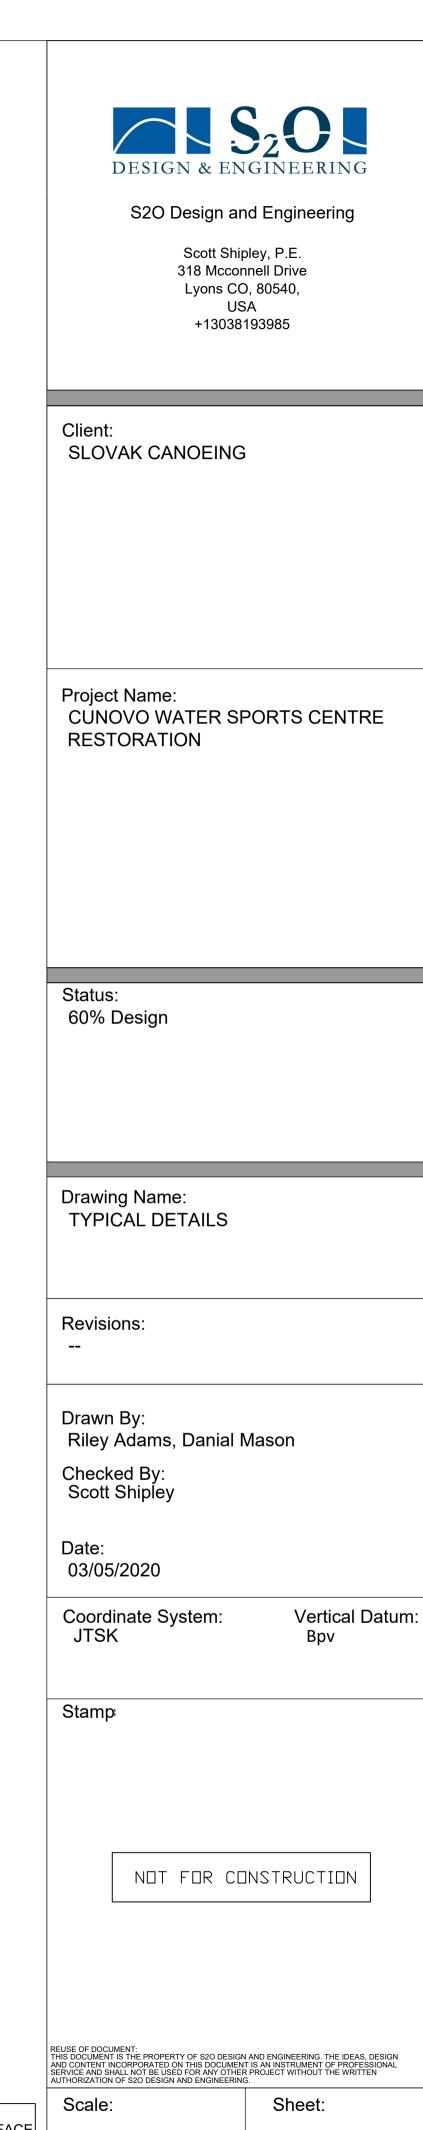

WW-4.0

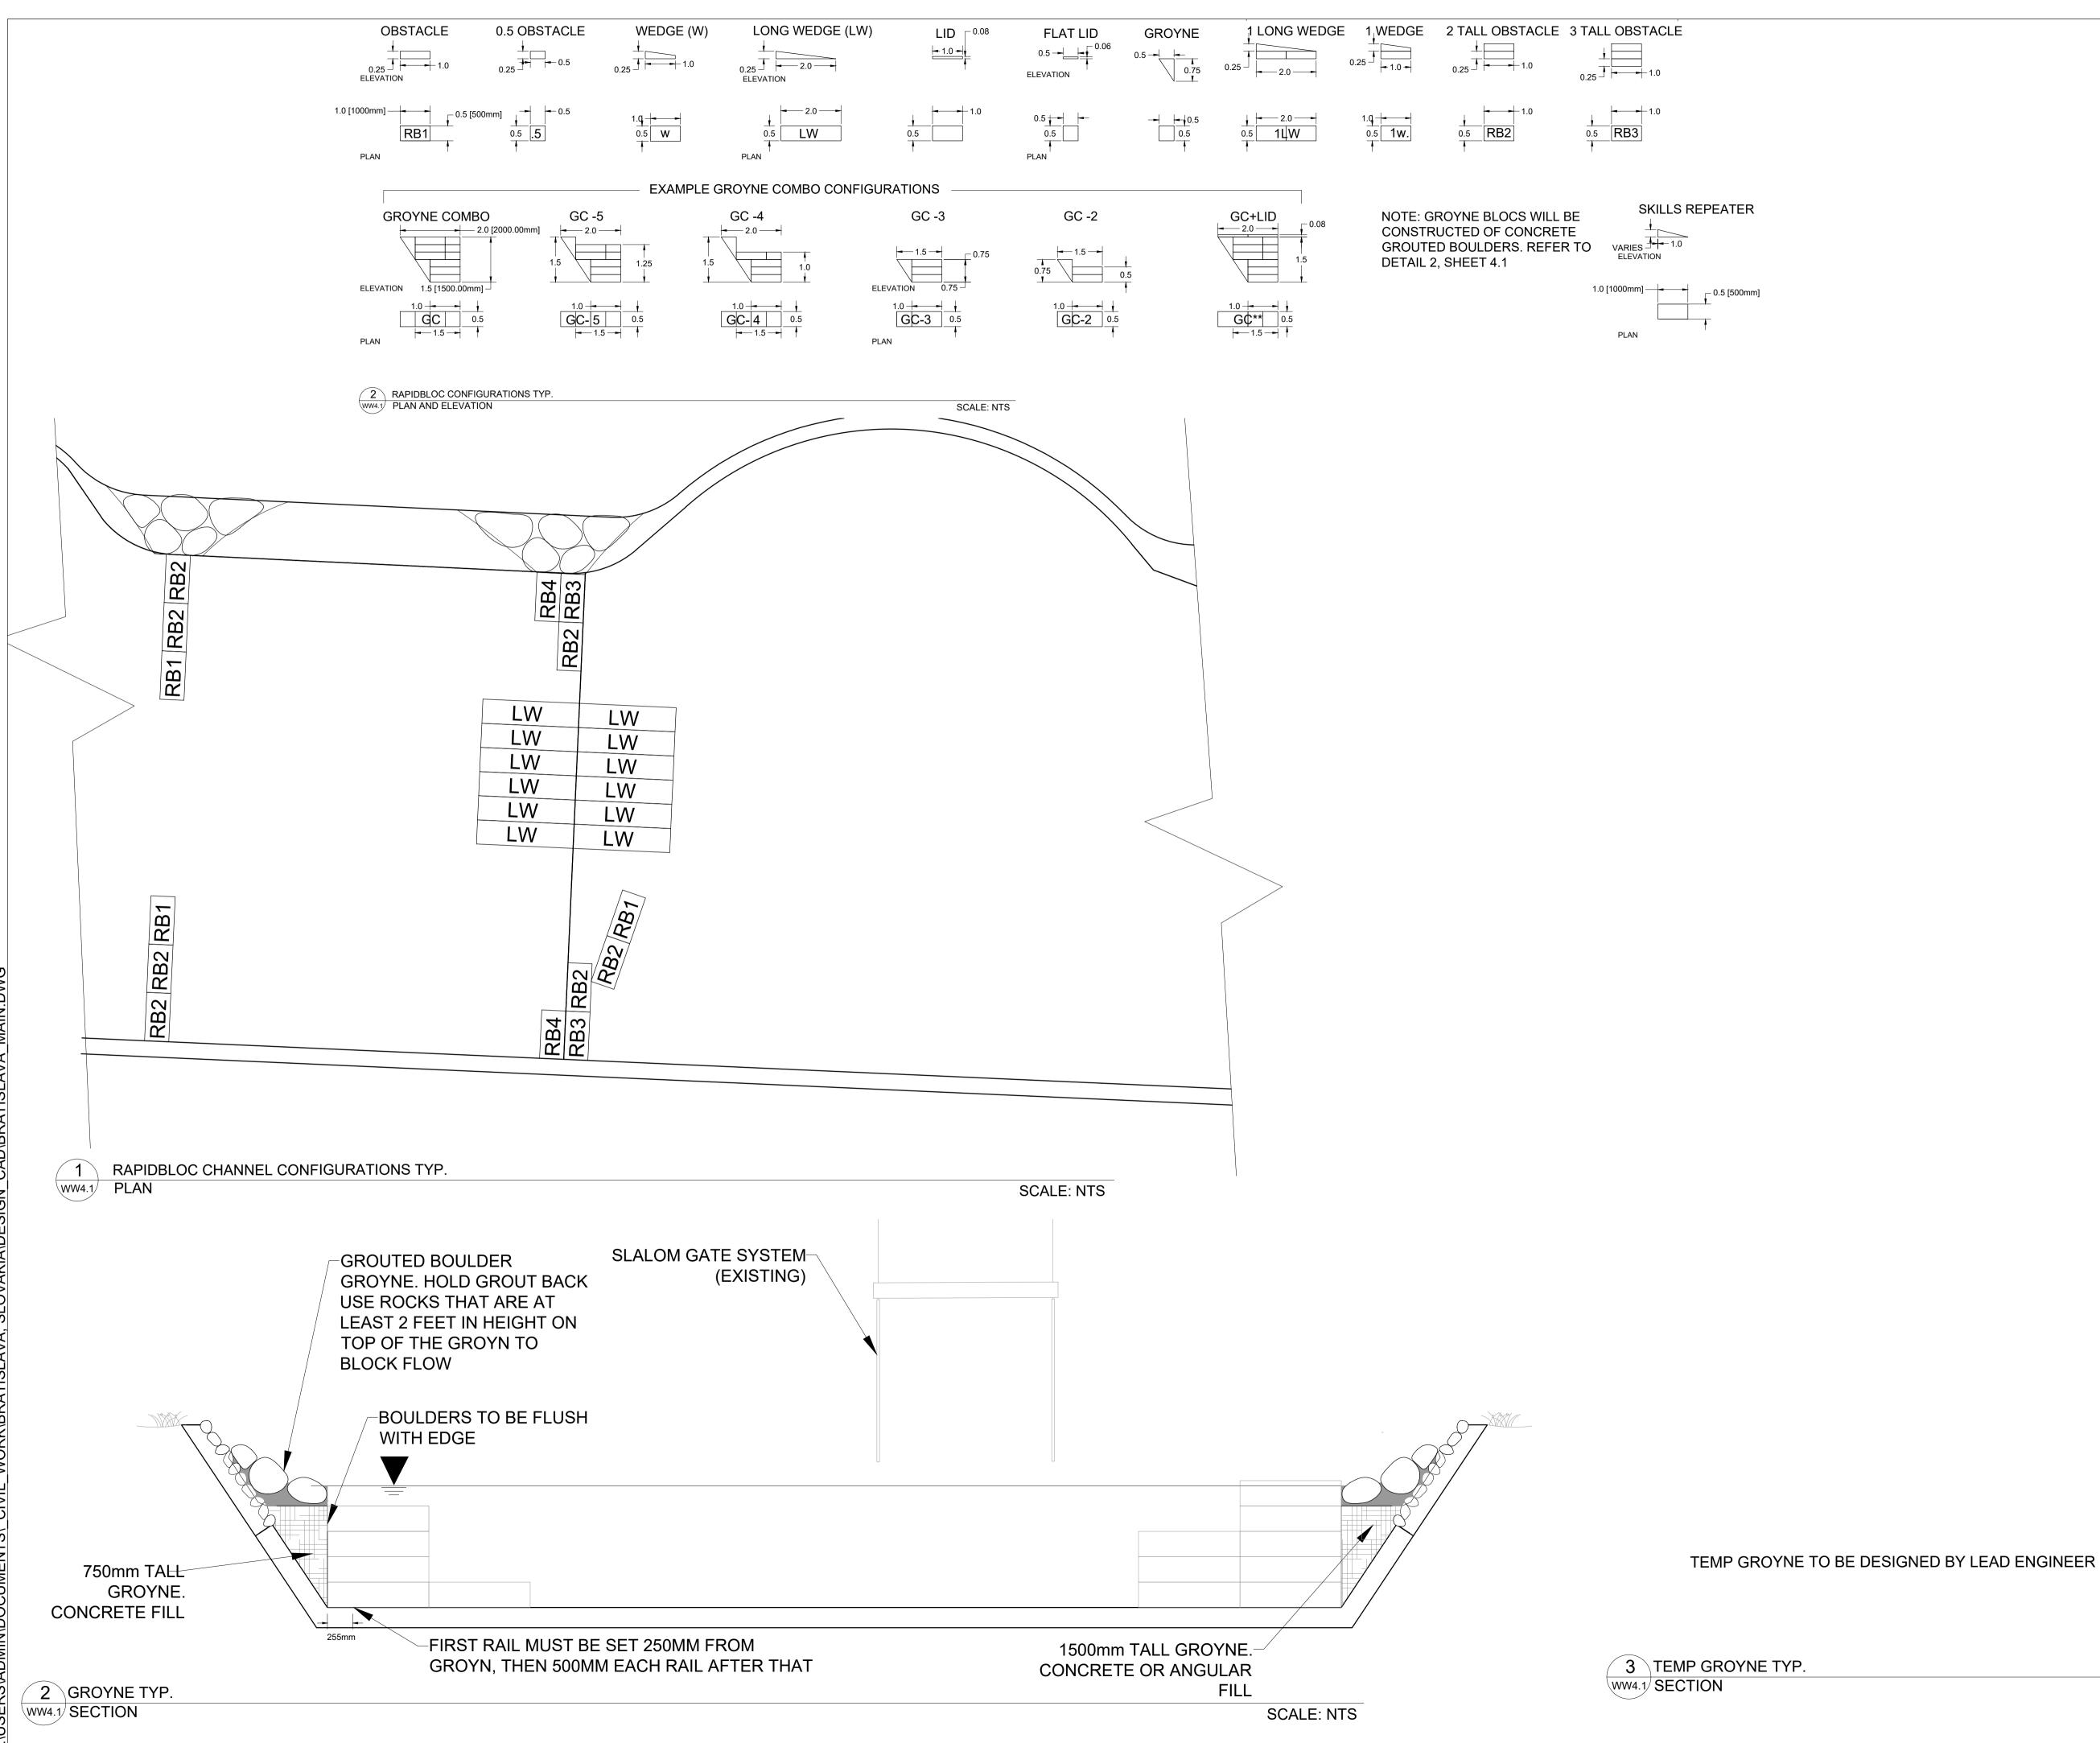

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Client: SLOVAK CANOEING
Project Name: CUNOVO WATER SPORTS CENTRE RESTORATION
Status: 60% Design
Drawing Name: TYPICAL DETAILS
Revisions:
Drawn By: Riley Adams, Danial Mason Checked By: Scott Shipley Date: 03/05/2020
Coordinate System: Vertical Datum: JTSK Bpv
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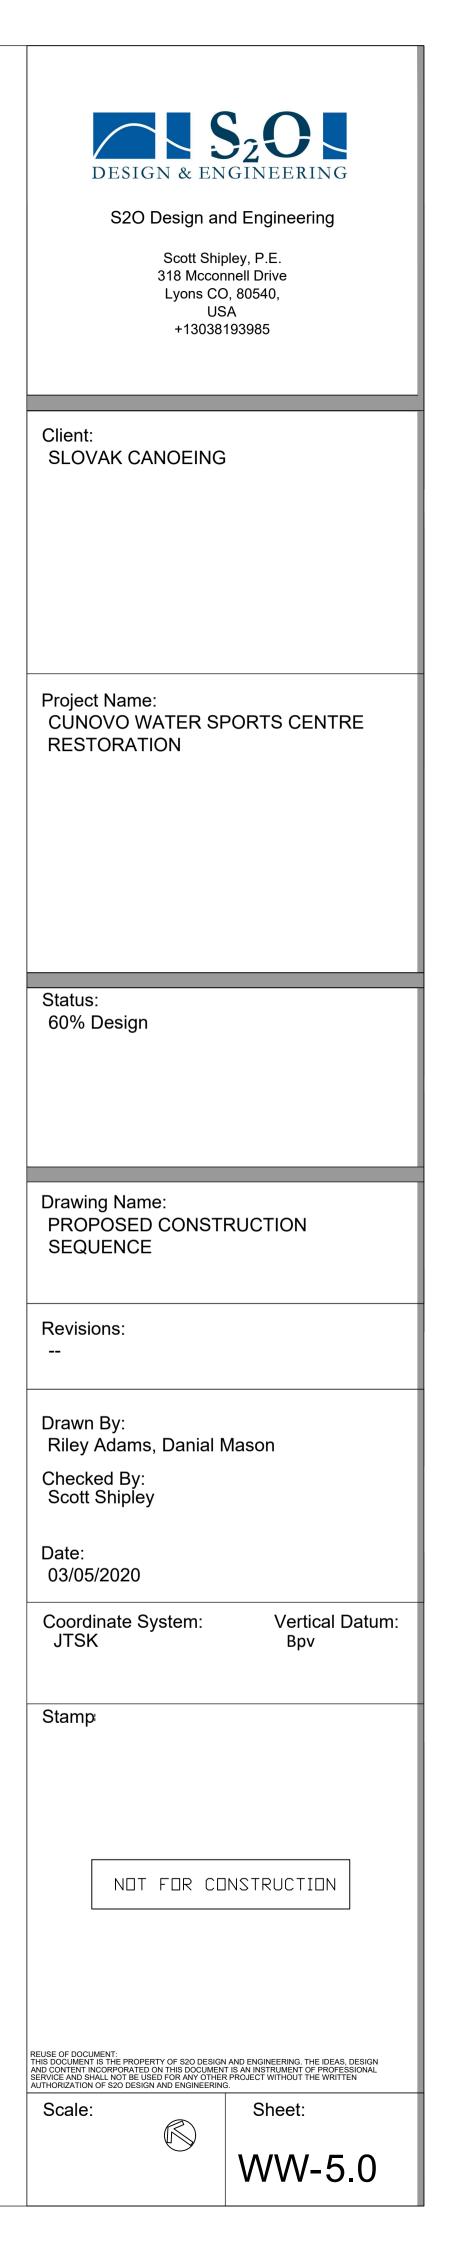


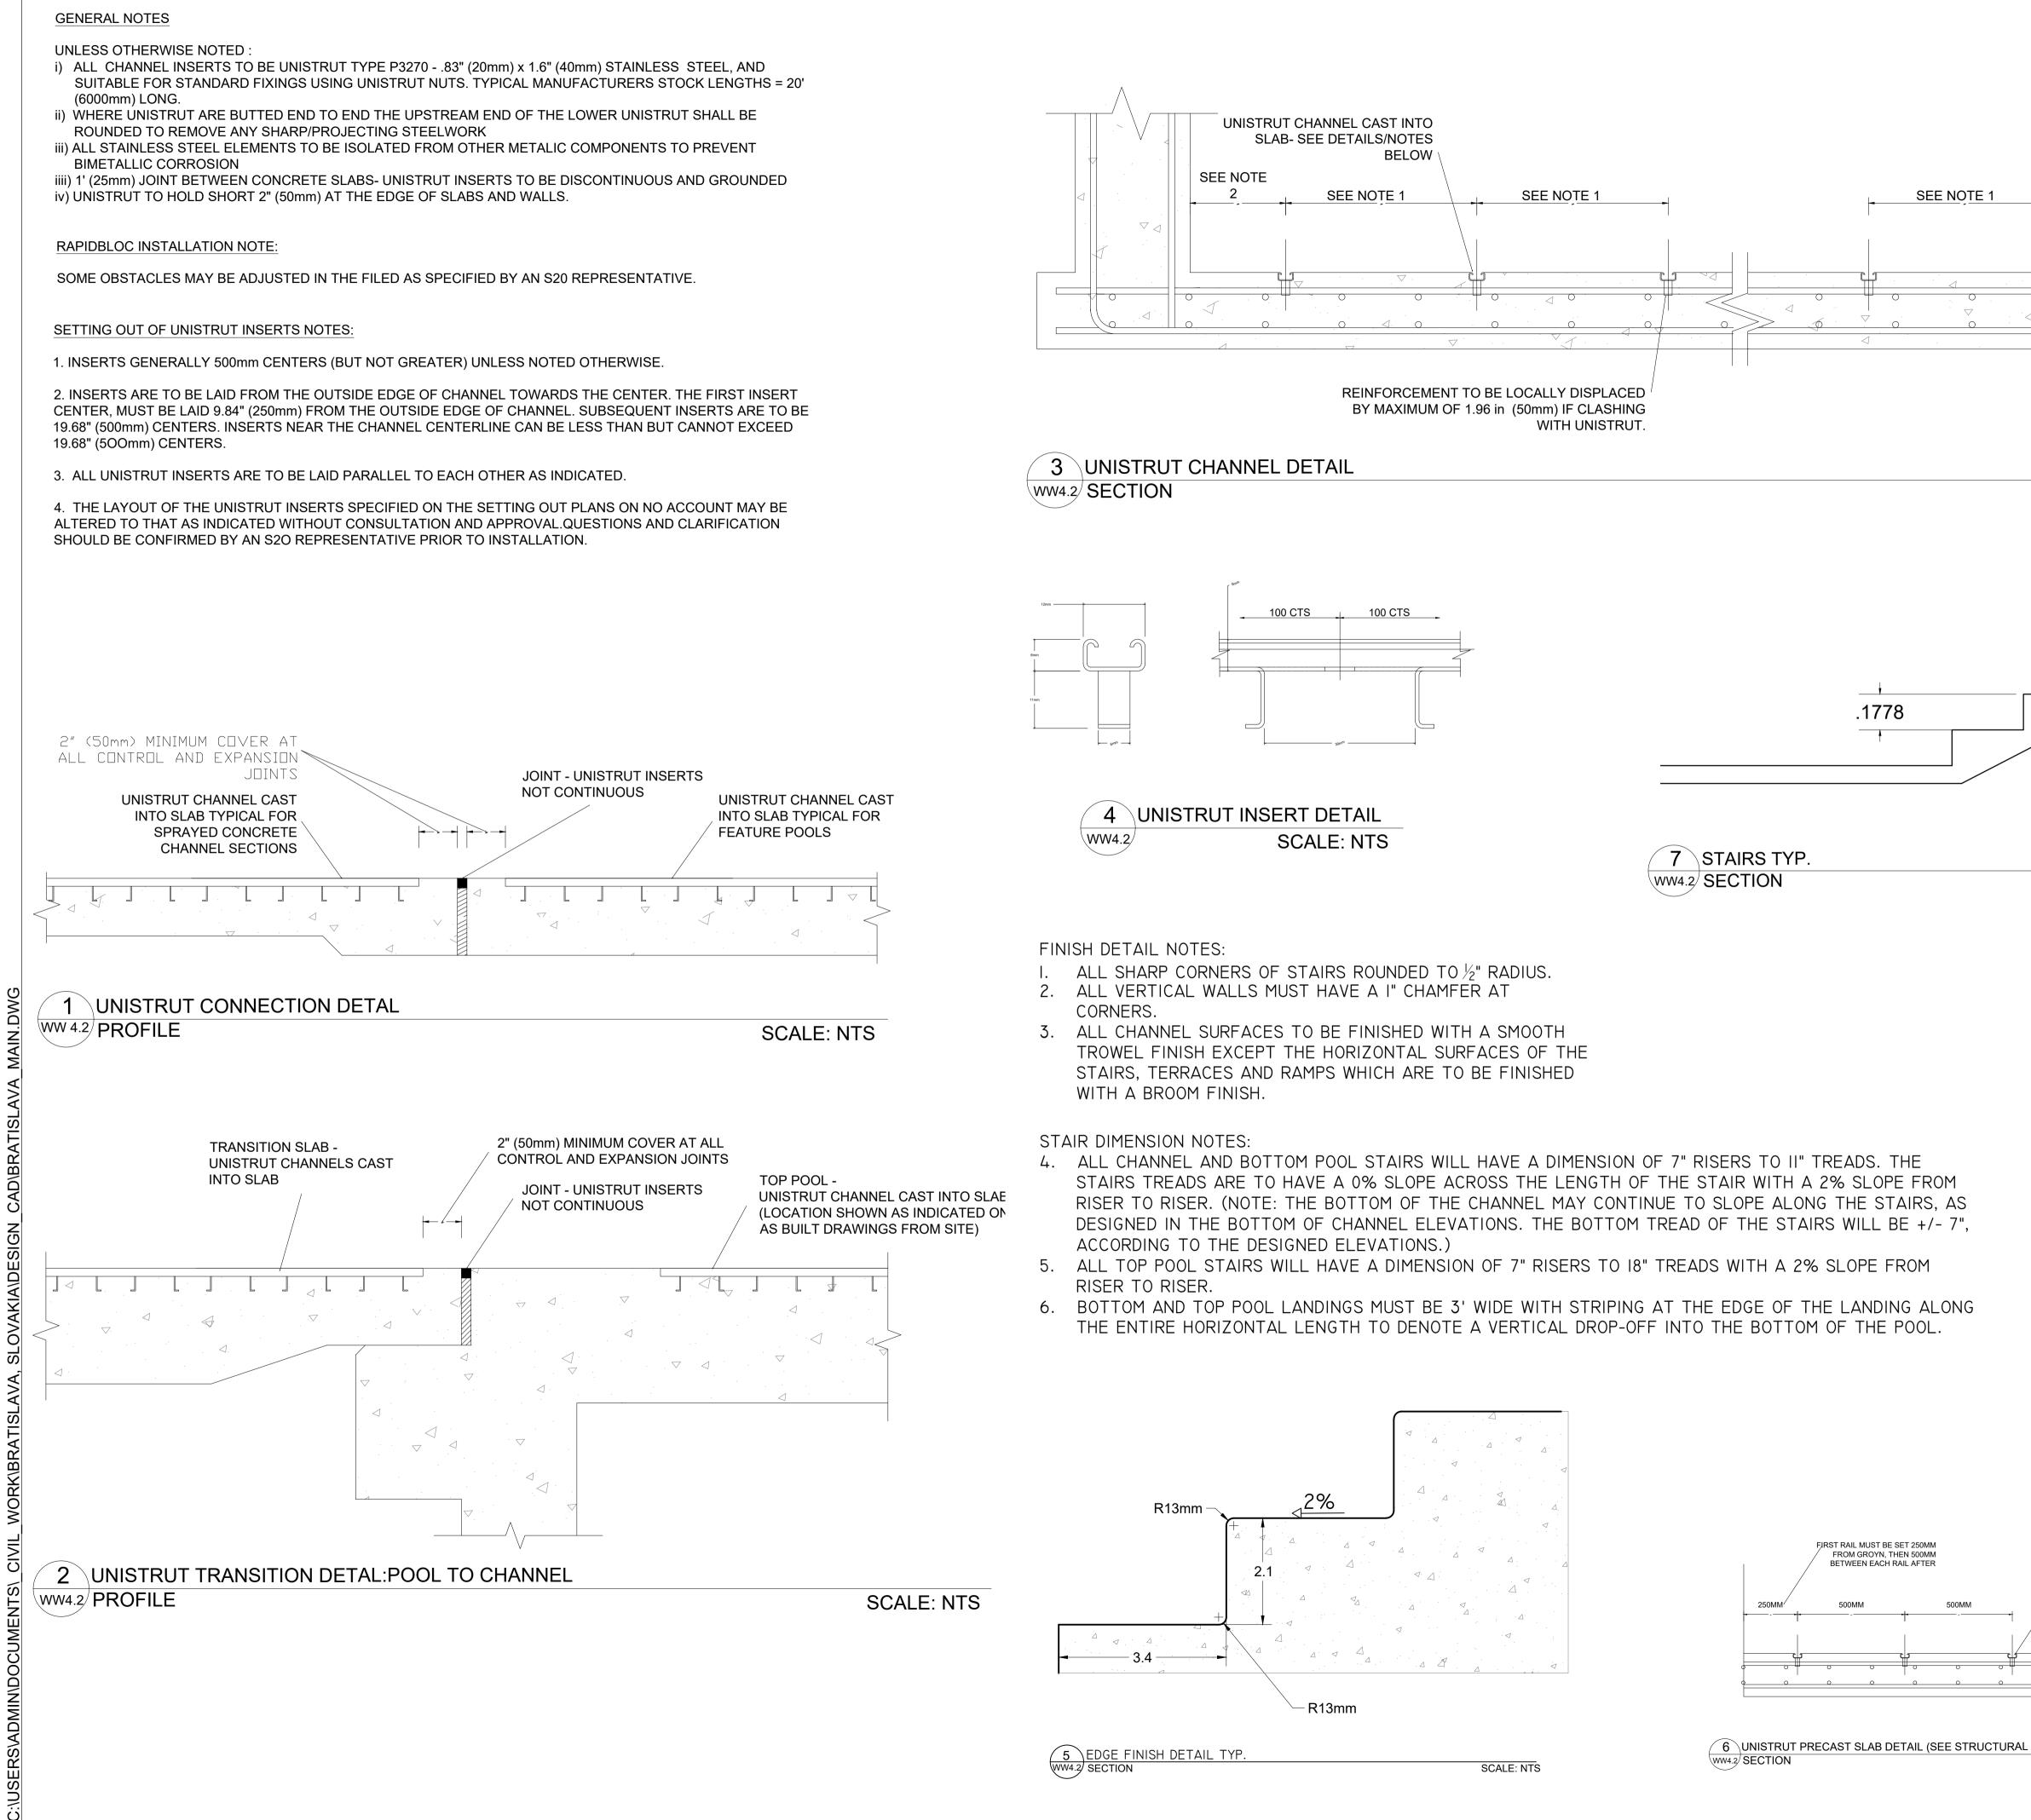SEE NOTE 1 SEE NOTE 1 SEE NOTE 2 NOTE 2 SEE NOTE 2 SEE NOTE 2 SEE NOTE 2 SEE SEE NOTE 2 SEE SEE SEE SEE SEE SEE SEE SE	Client: SLOVAK CANOEING
SCALE: NTS	
.1778	Project Name: CUNOVO WATER SPORTS CENTRE RESTORATION
AIRS TYP. CTION SCALE: NTS	Status: 60% Design
ERS TO II" TREADS. THE NR WITH A 2% SLOPE FROM LOPE ALONG THE STAIRS, AS THE STAIRS WILL BE +/- 7", WITH A 2% SLOPE FROM EDGE OF THE LANDING ALONG HE BOTTOM OF THE POOL.	Drawing Name: TYPICAL DETAILS Revisions: Drawn By: Riley Adams, Danial Mason Checked By: Scott Shipley Date: 03/05/2020 Coordinate System: Vertical Datum: JTSK Bpv
UNISTRUT PRECAST SLAB DETAIL (SEE STRUCTURAL DRAWINGS FOR THICKNESS	REUSE OF DOCUMENT: THIS DOCUMENT IS THE PROPERTY OF \$20 DESIGN AND ENGINEERING. THE IDEAS, DESIGN AND CONTENT INCOMPORATED ON THIS DOCUMENT IS AN INSTRUMENT OF PROPESSIONAL SERVICE AND SHALL NOT BE USED FOR ANY OTHER PROJECT WITHOUT THE WRITTEN AUTHORIZATION OF \$20 DESIGN AND ENGINEERING. Scale: Sheet: WWW-4.2.2


5 EDGE FINISH DETAIL TYP. WW4.2 SECTION


SCALE: NTS

NOTE: PLEASE SEE STRUCTURAL ENGINEERING PLANS



NOTE: PLEASE SEE STRUCTURAL ENGINEERING PLANS

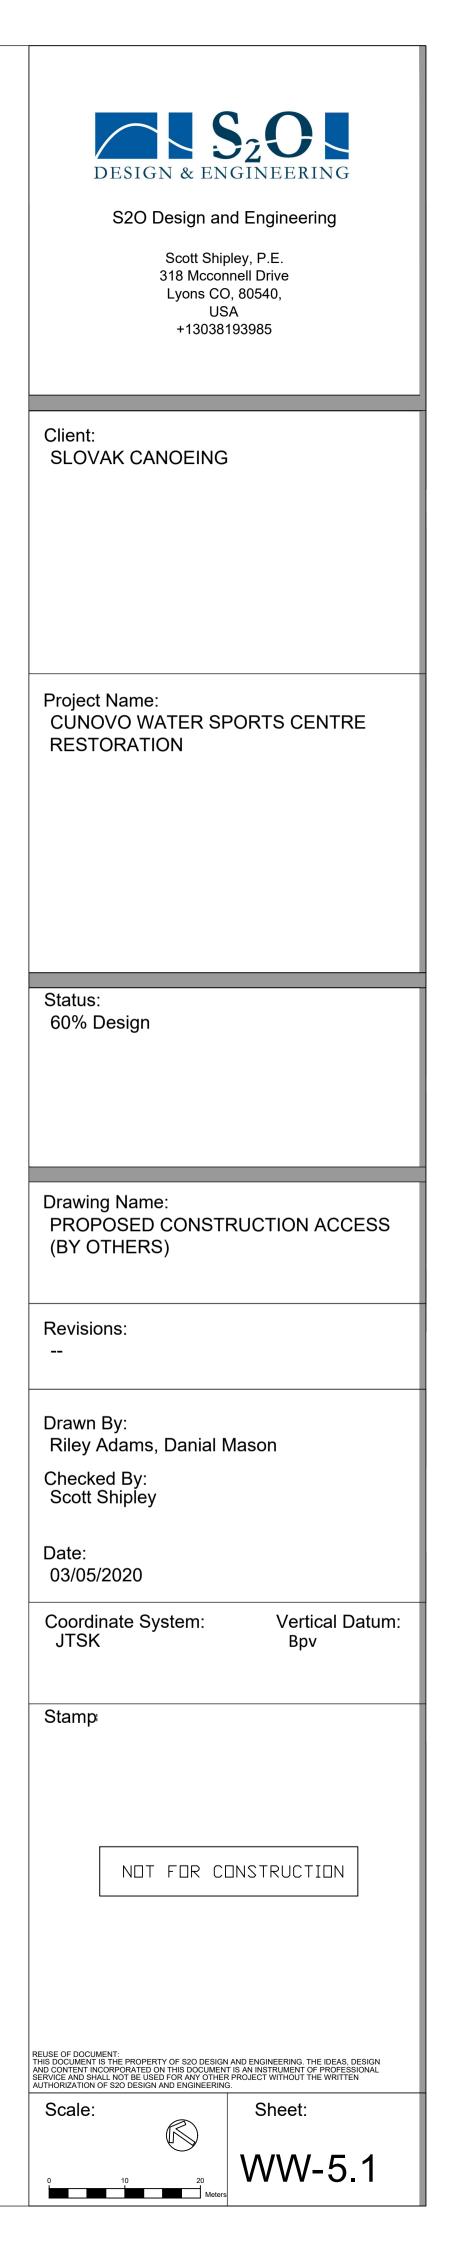

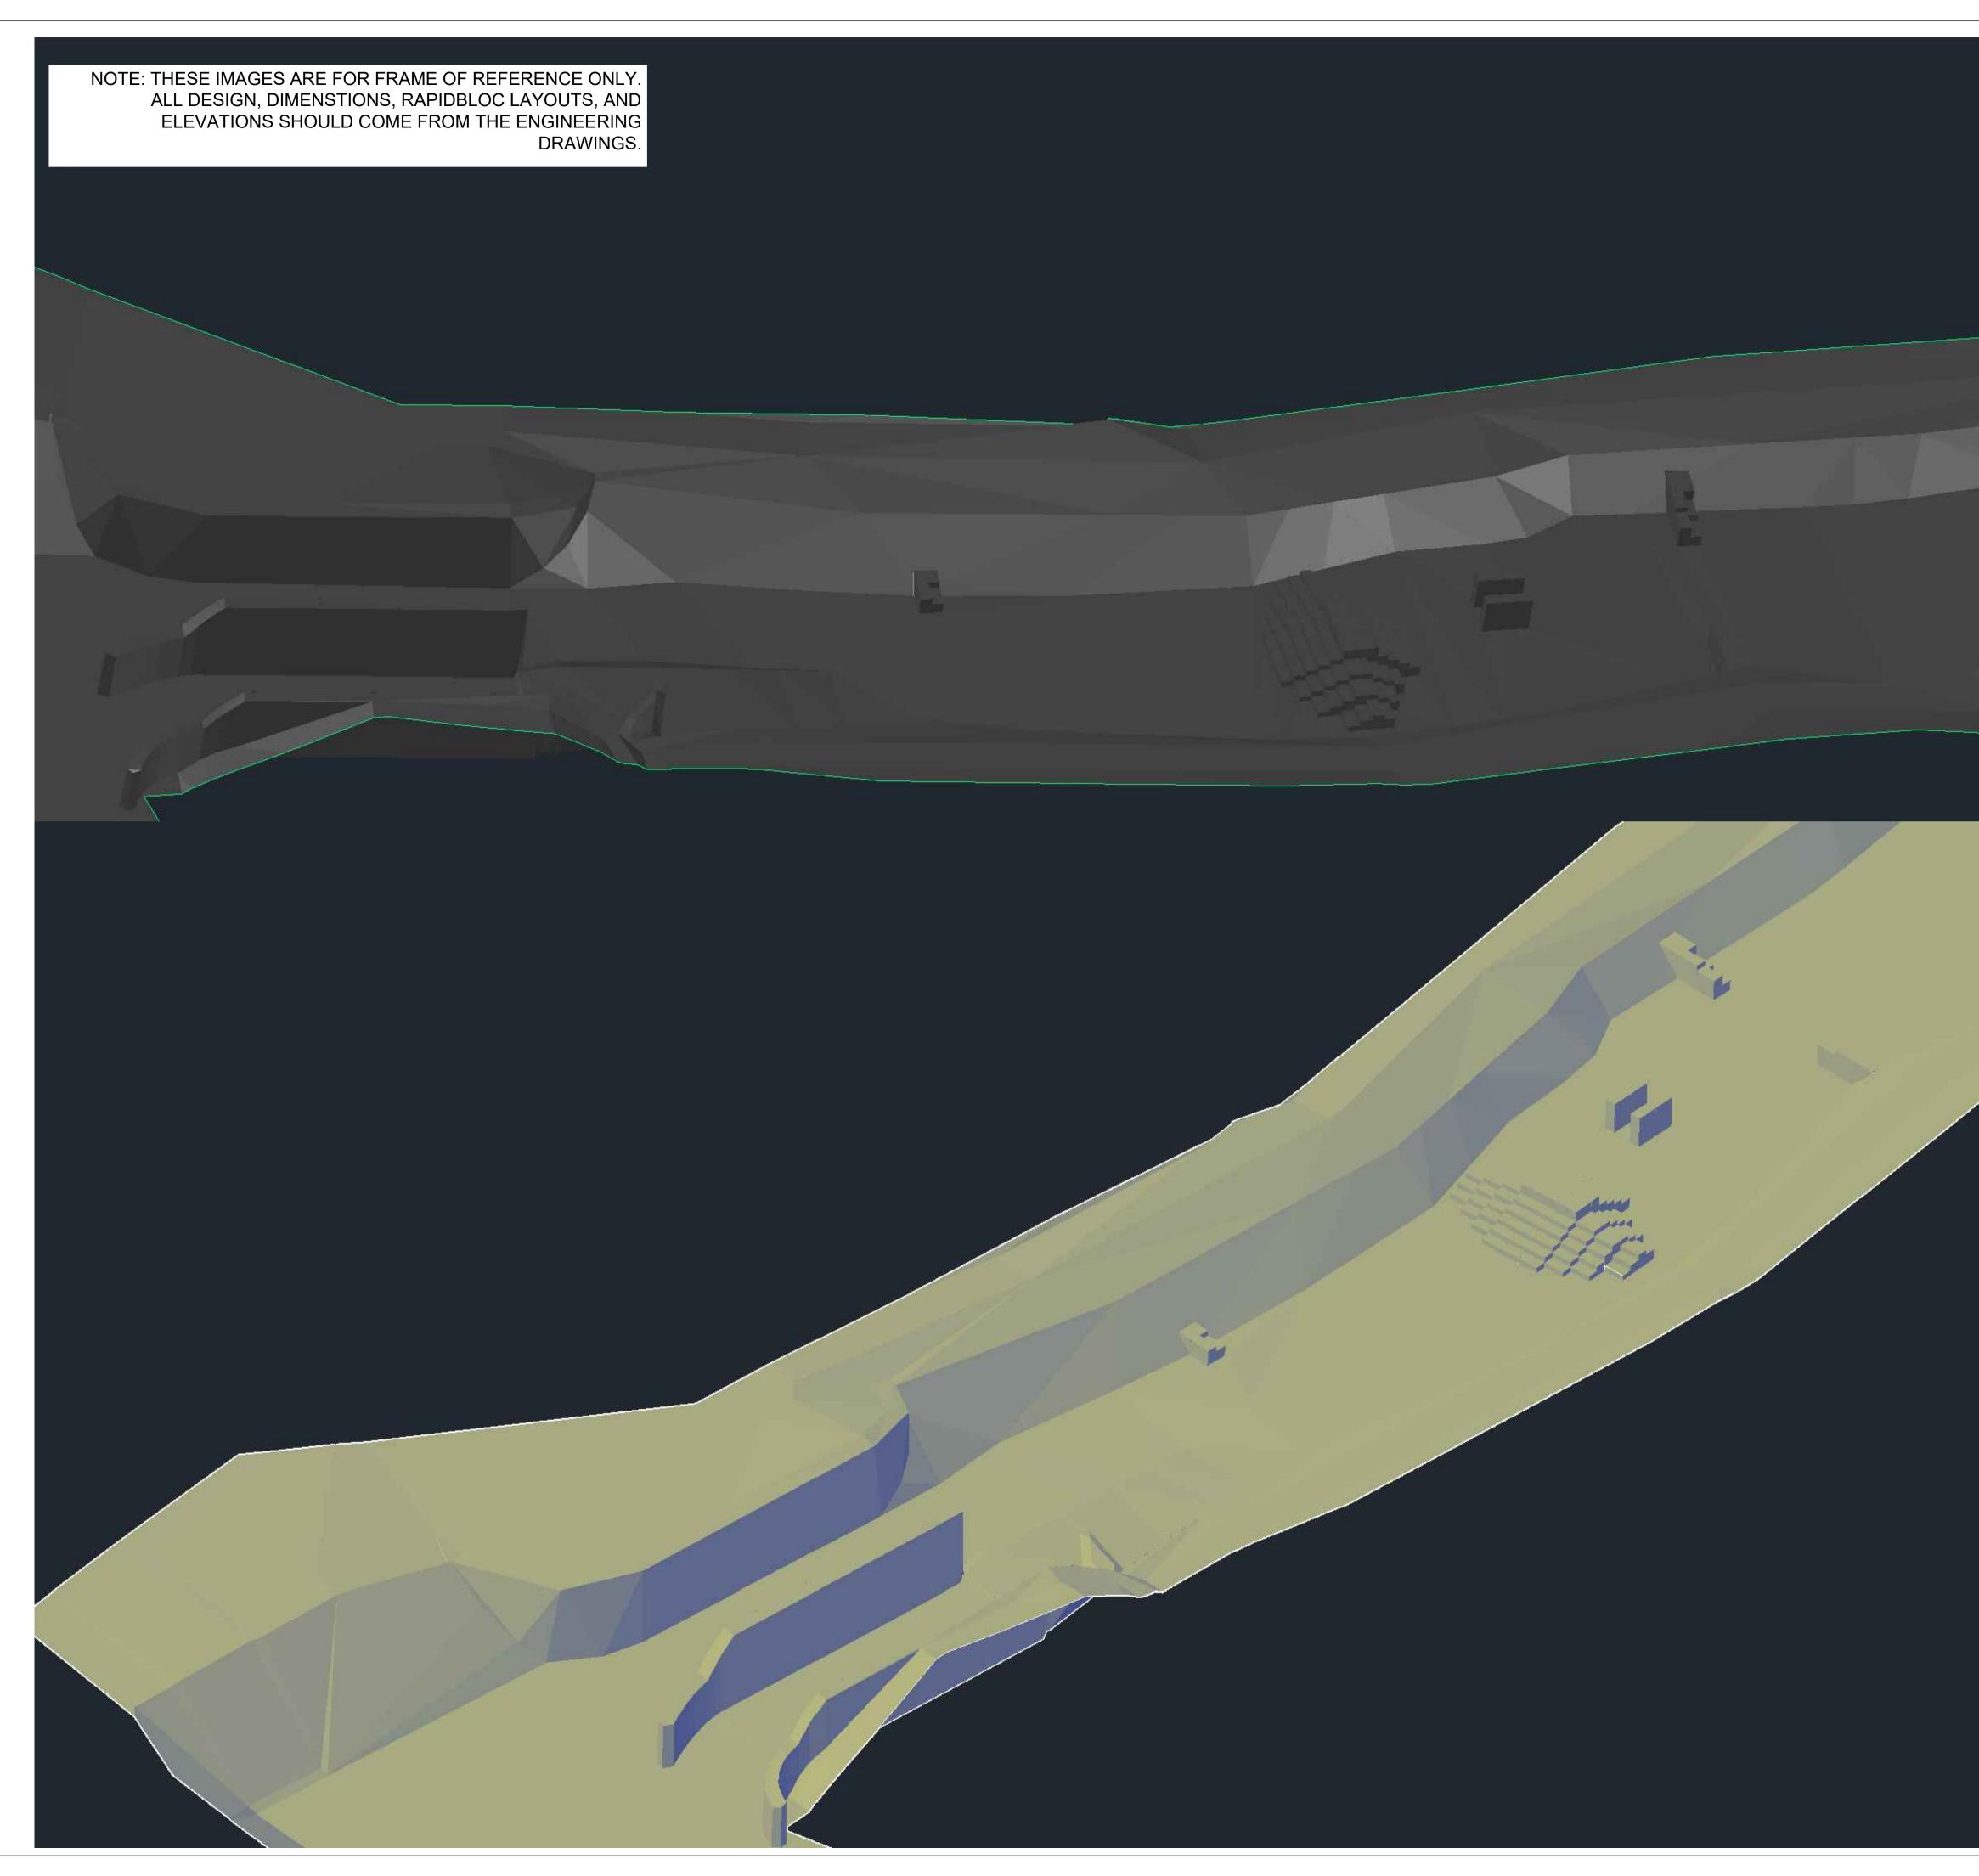





S2O Design and Engineering

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Client: SLOVAK CANOEING

Project Name: CUNOVO WATER SPORTS CENTRE RESTORATION

Status: 60% Design

Drawing Name: ISOMETRIC VIEW (1)

Revisions:

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Drawn By: Riley Adams, Danial Mason Checked By: Scott Shipley

Date: 03/05/2020

Coordinate System: JTSK Vertical Datum: Bpv


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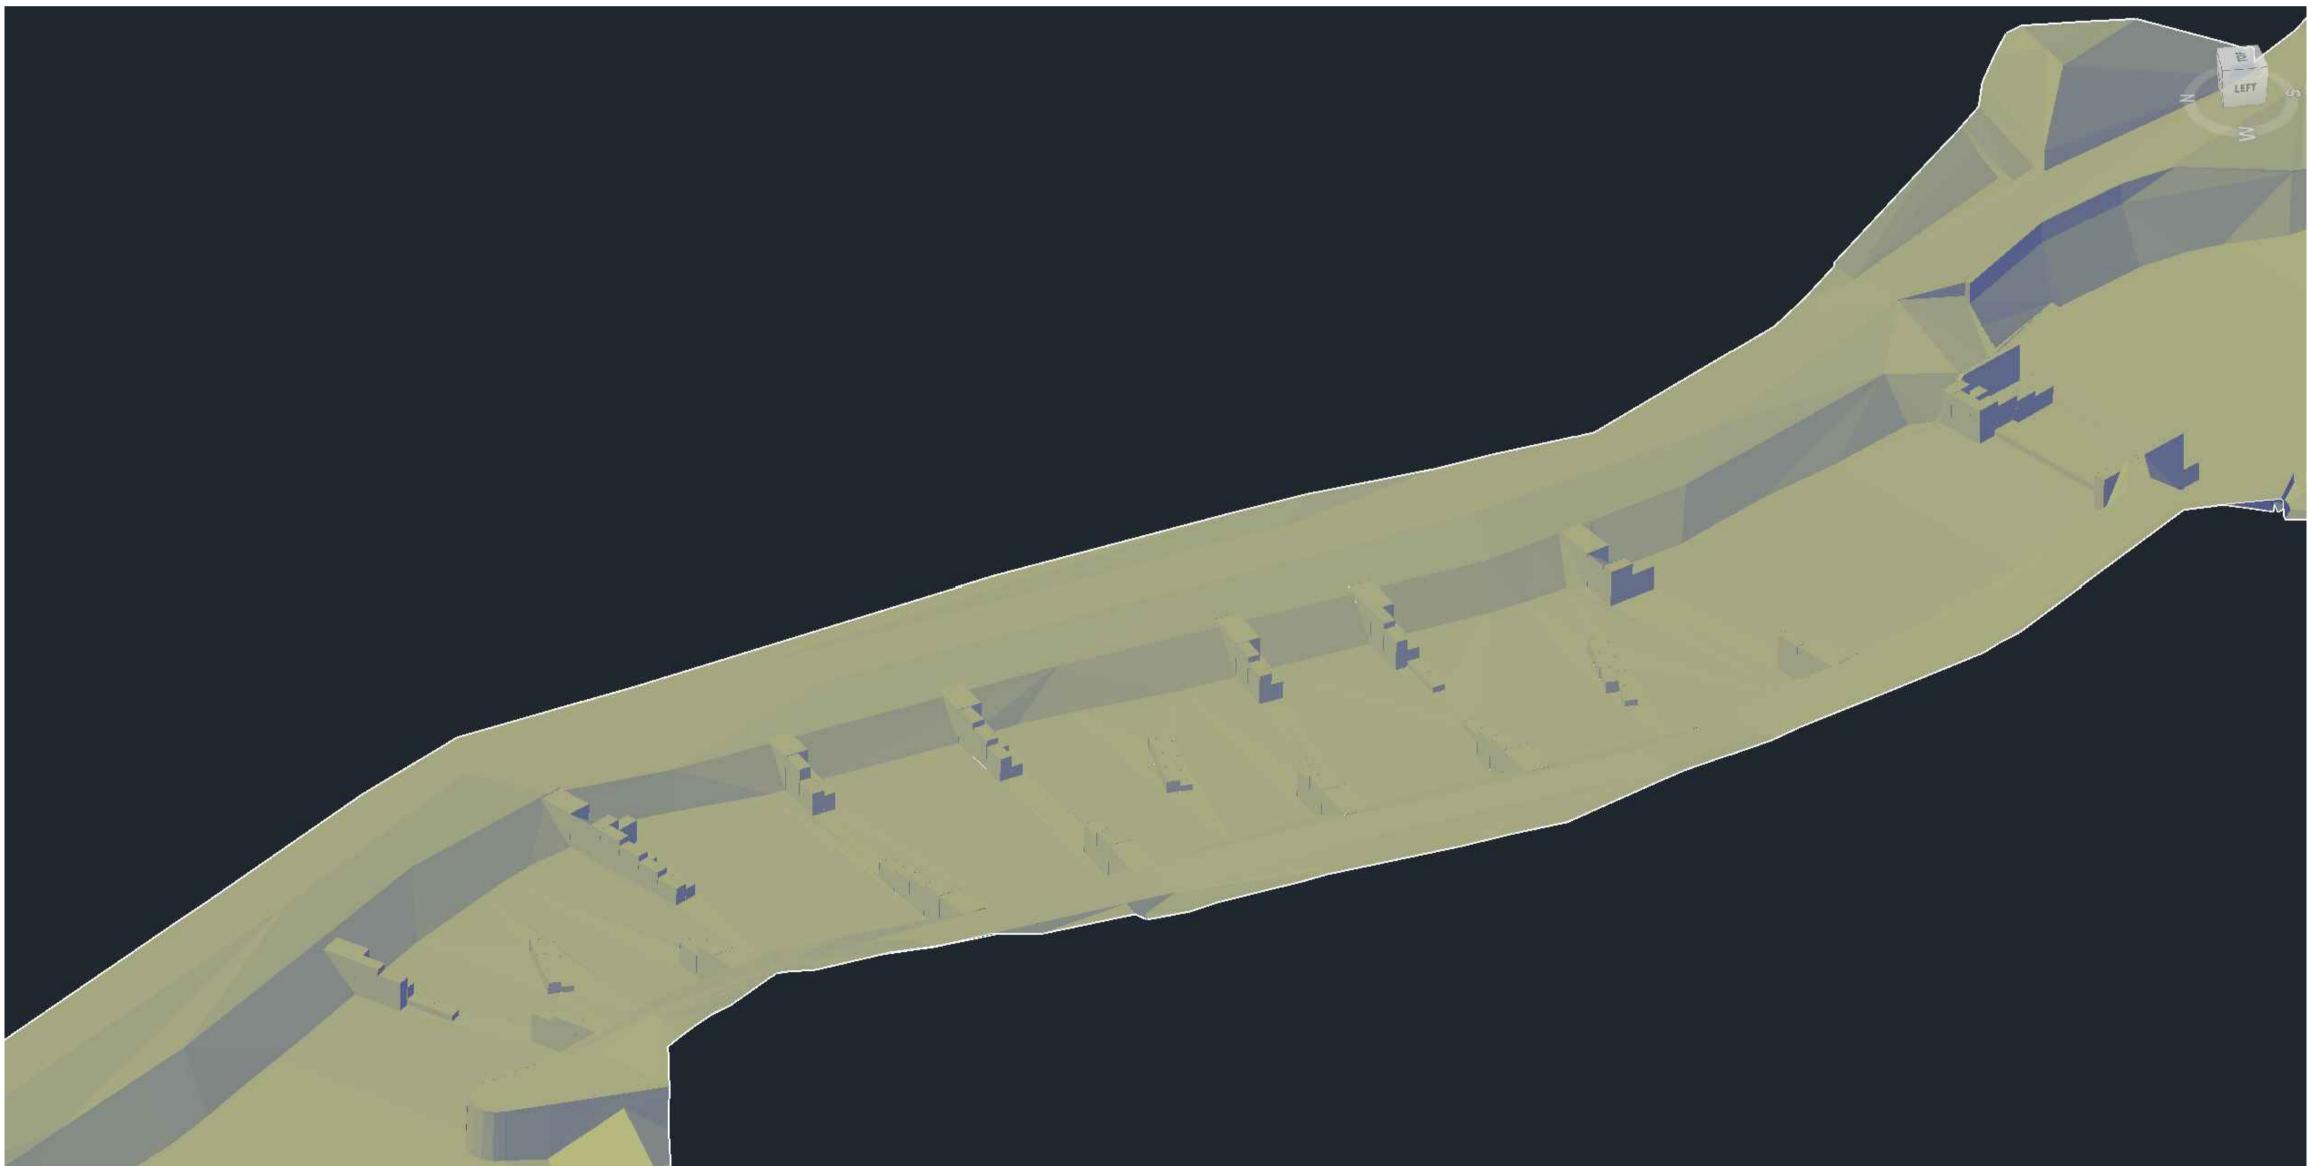
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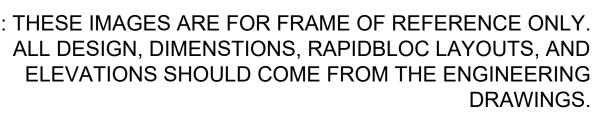
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Client: SLOVAK CANOEING

Project Name: CUNOVO WATER SPORTS CENTRE RESTORATION

Status: 60% Design

Drawing Name: ISOMETRIC VIEW (2)

Revisions: --
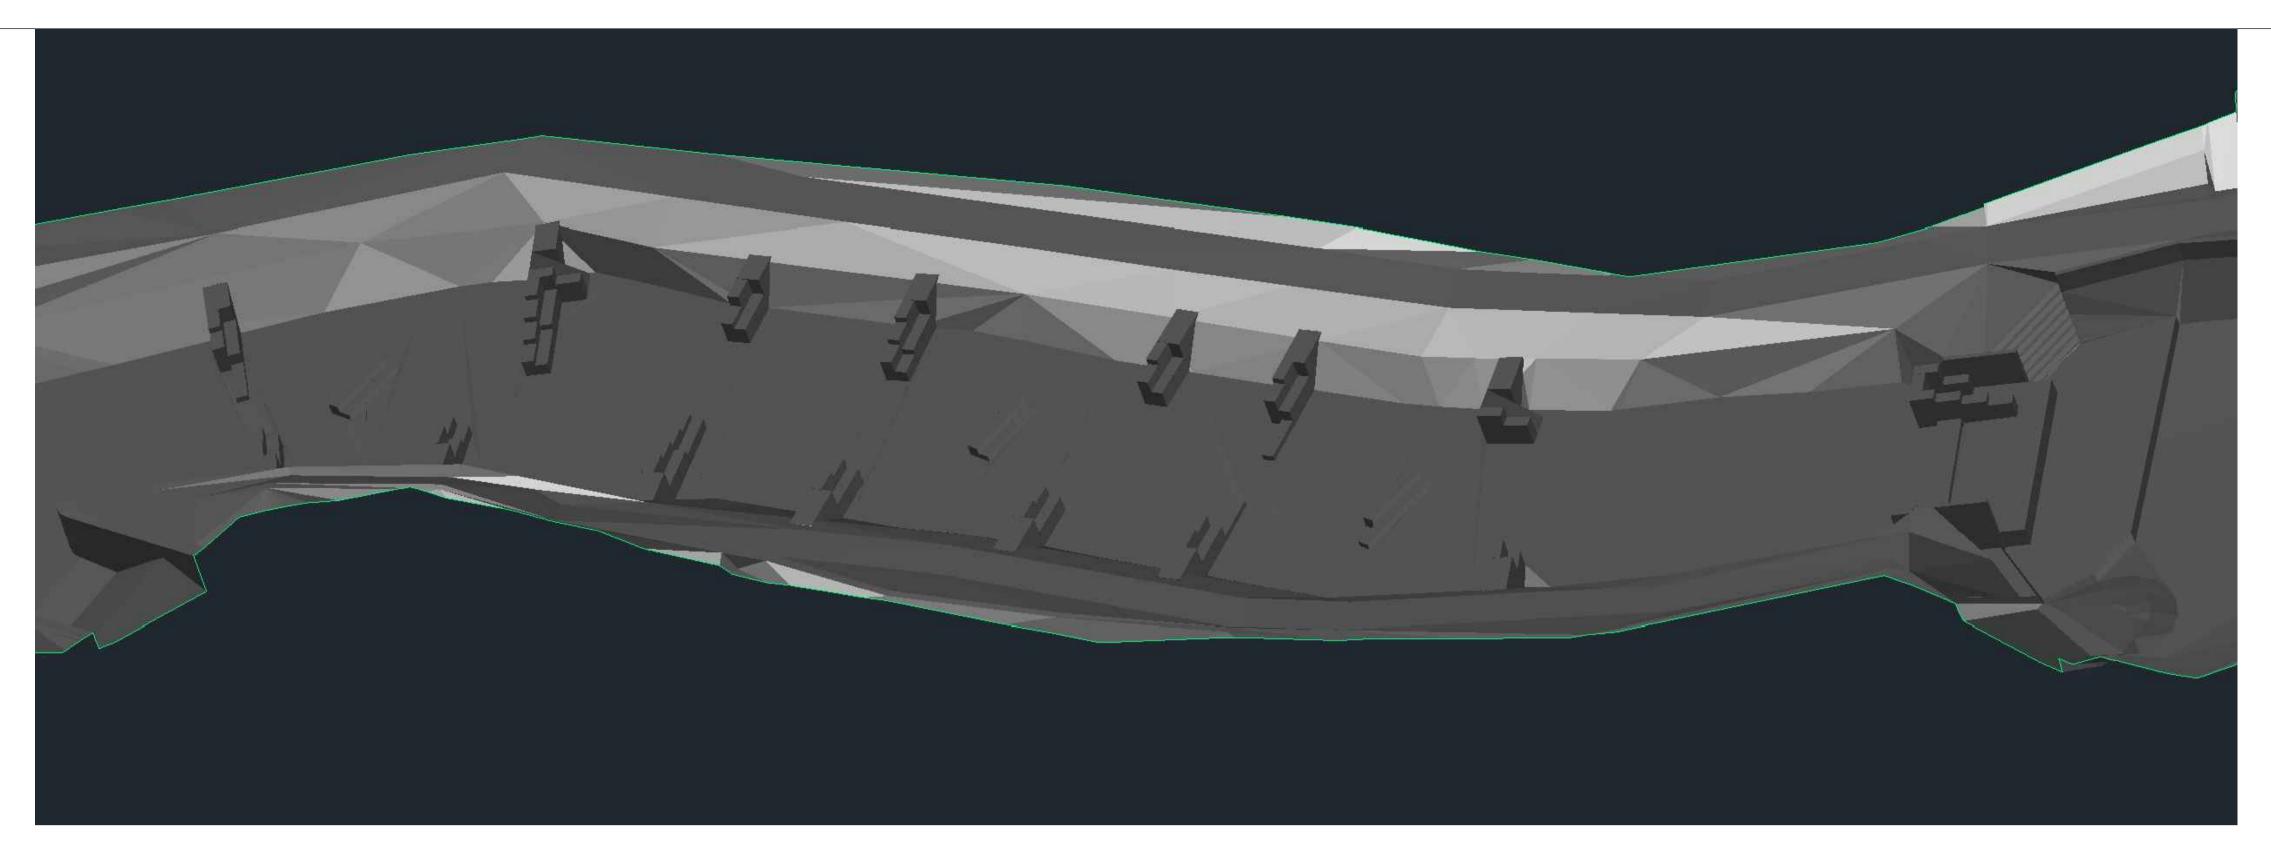
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Date: 03/05/2020

Coordinate System: JTSK


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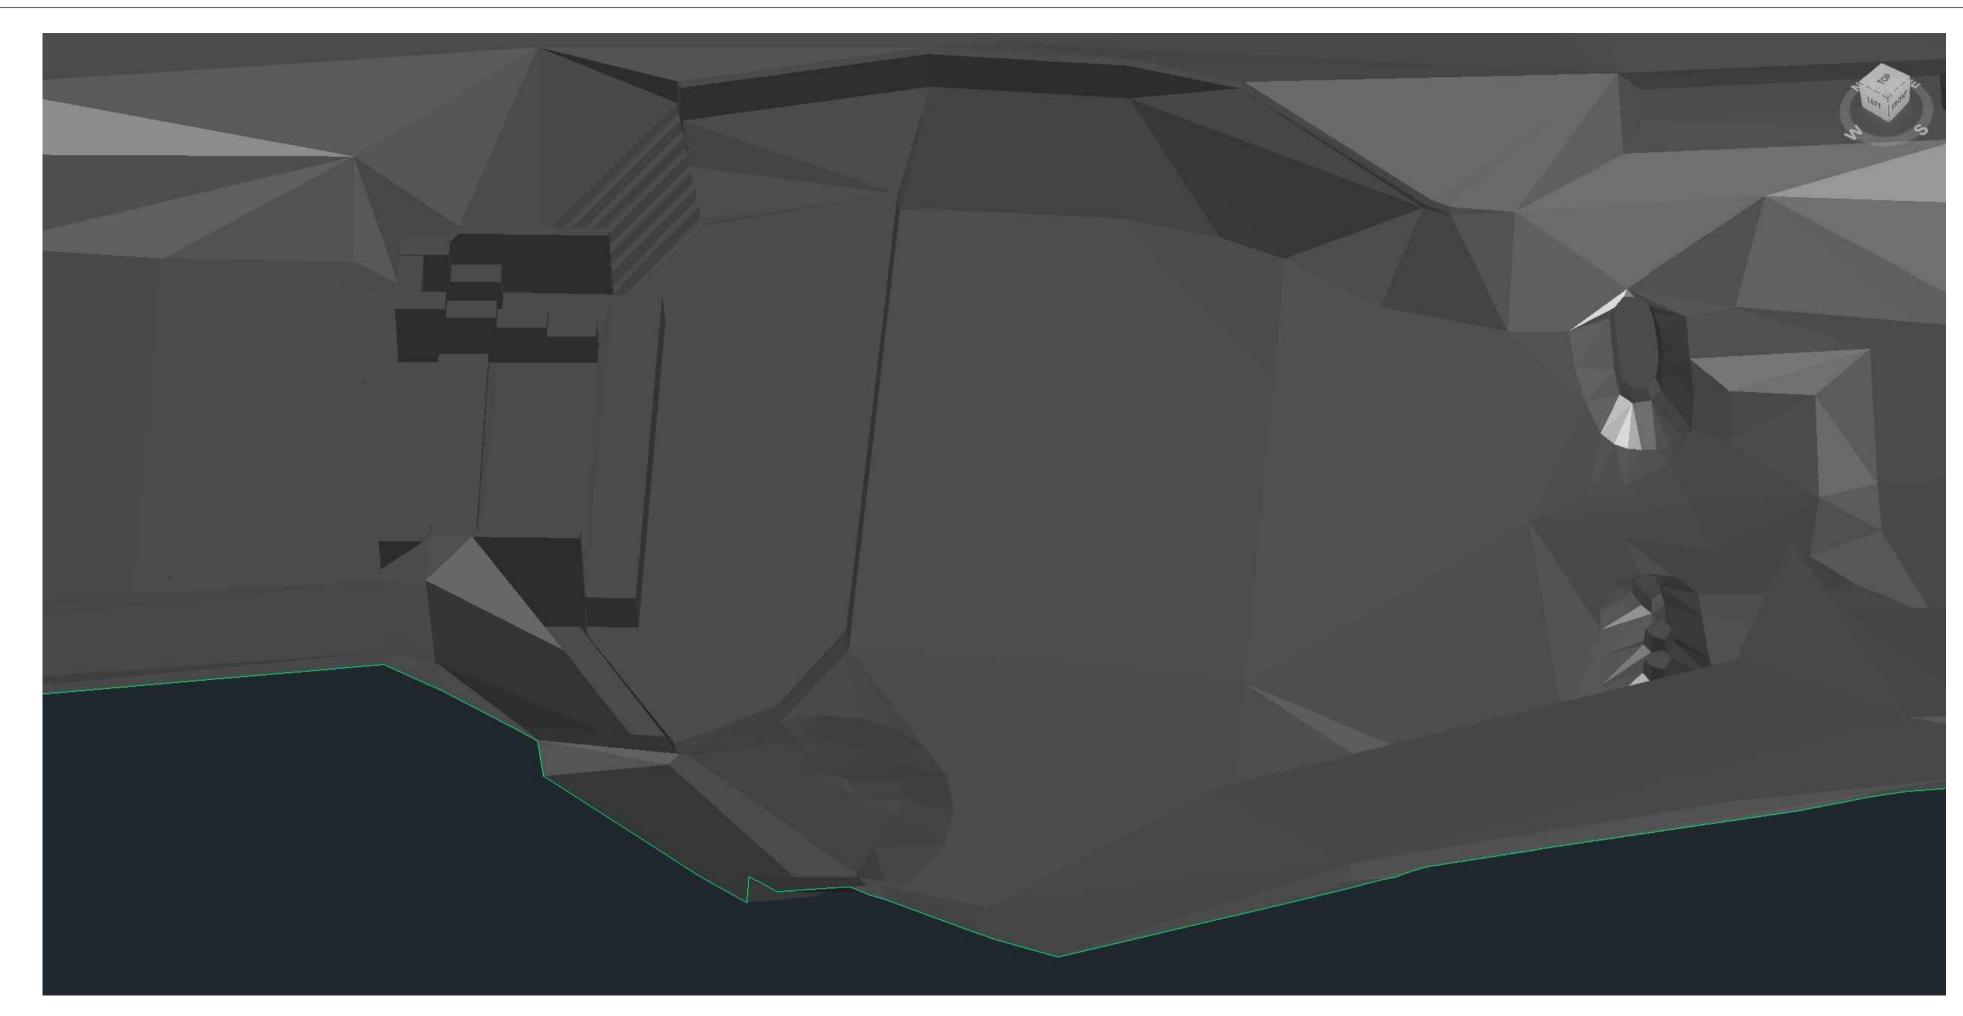
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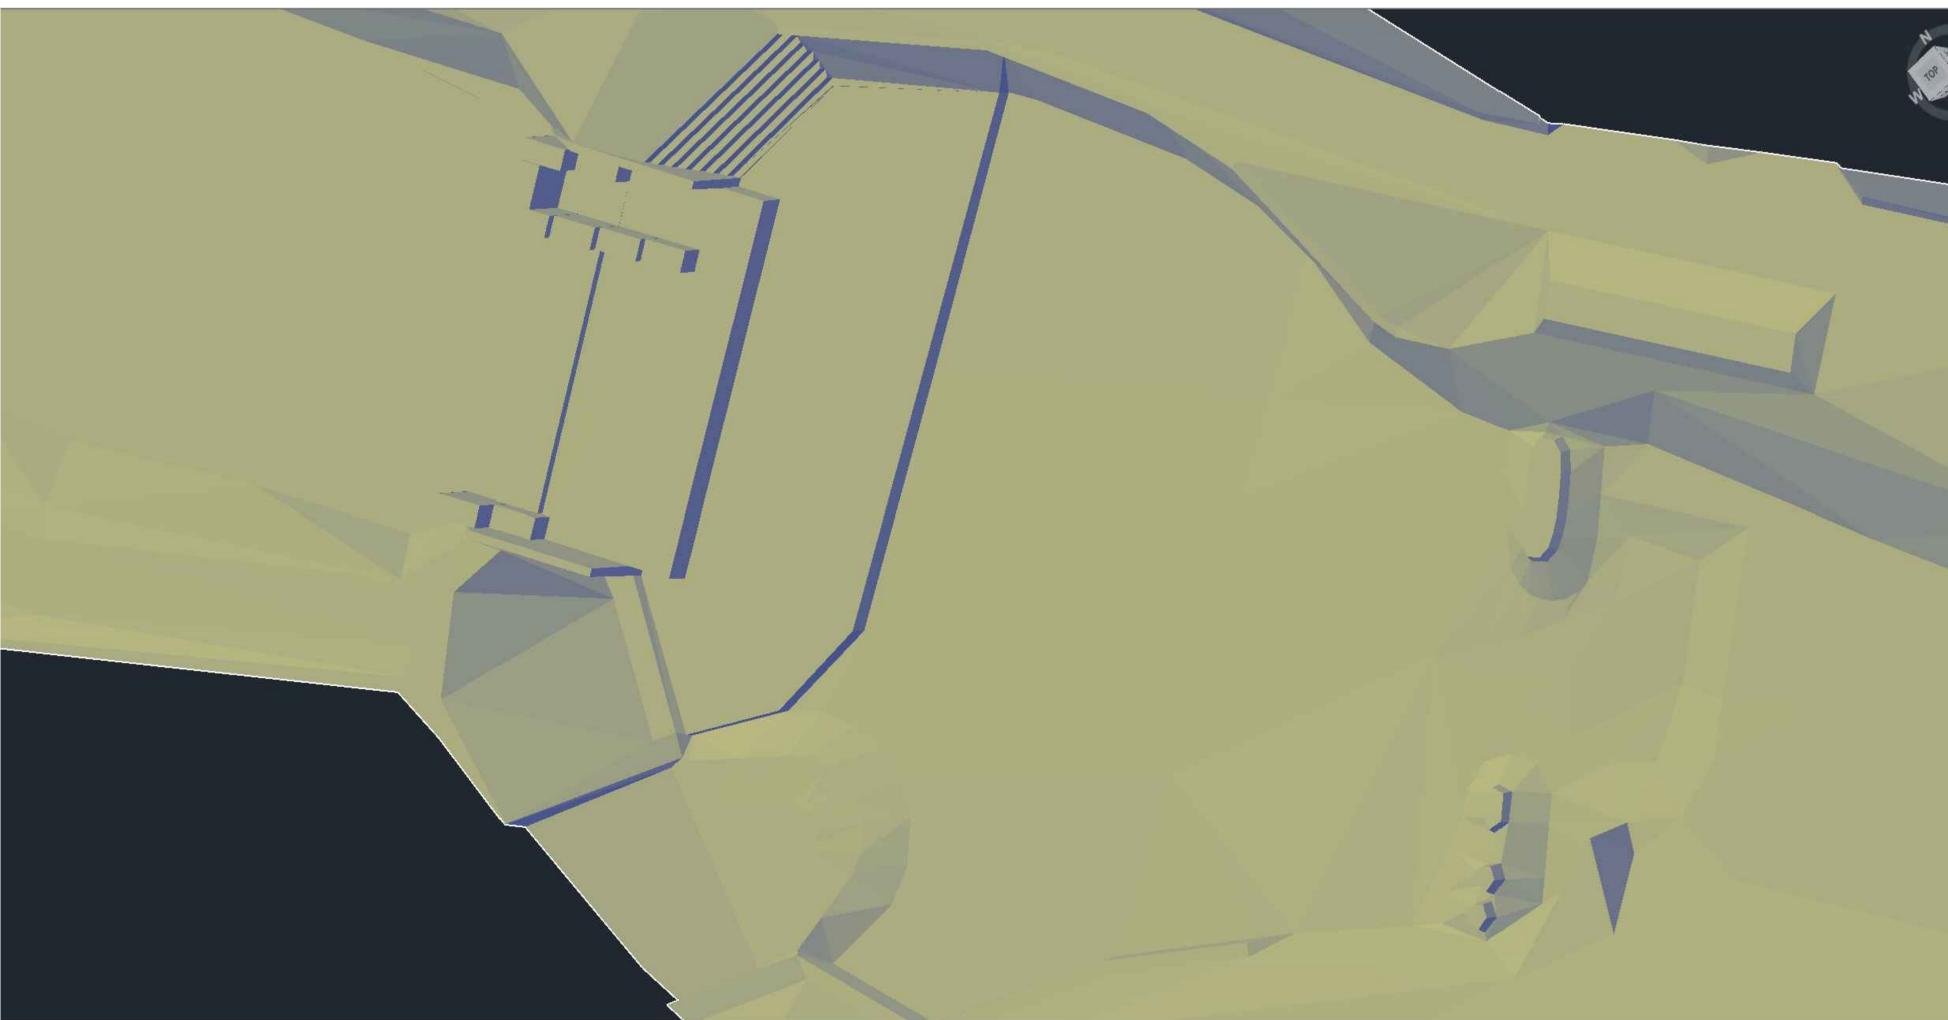
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Client: SLOVAK CANOEING

Project Name: CUNOVO WATER SPORTS CENTRE RESTORATION

Status: 60% Design

Drawing Name: ISOMETRIC VIEW (3)

Revisions:
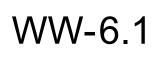
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Date: 03/05/2020

Coordinate System: JTSK Vertical Datum: Bpv


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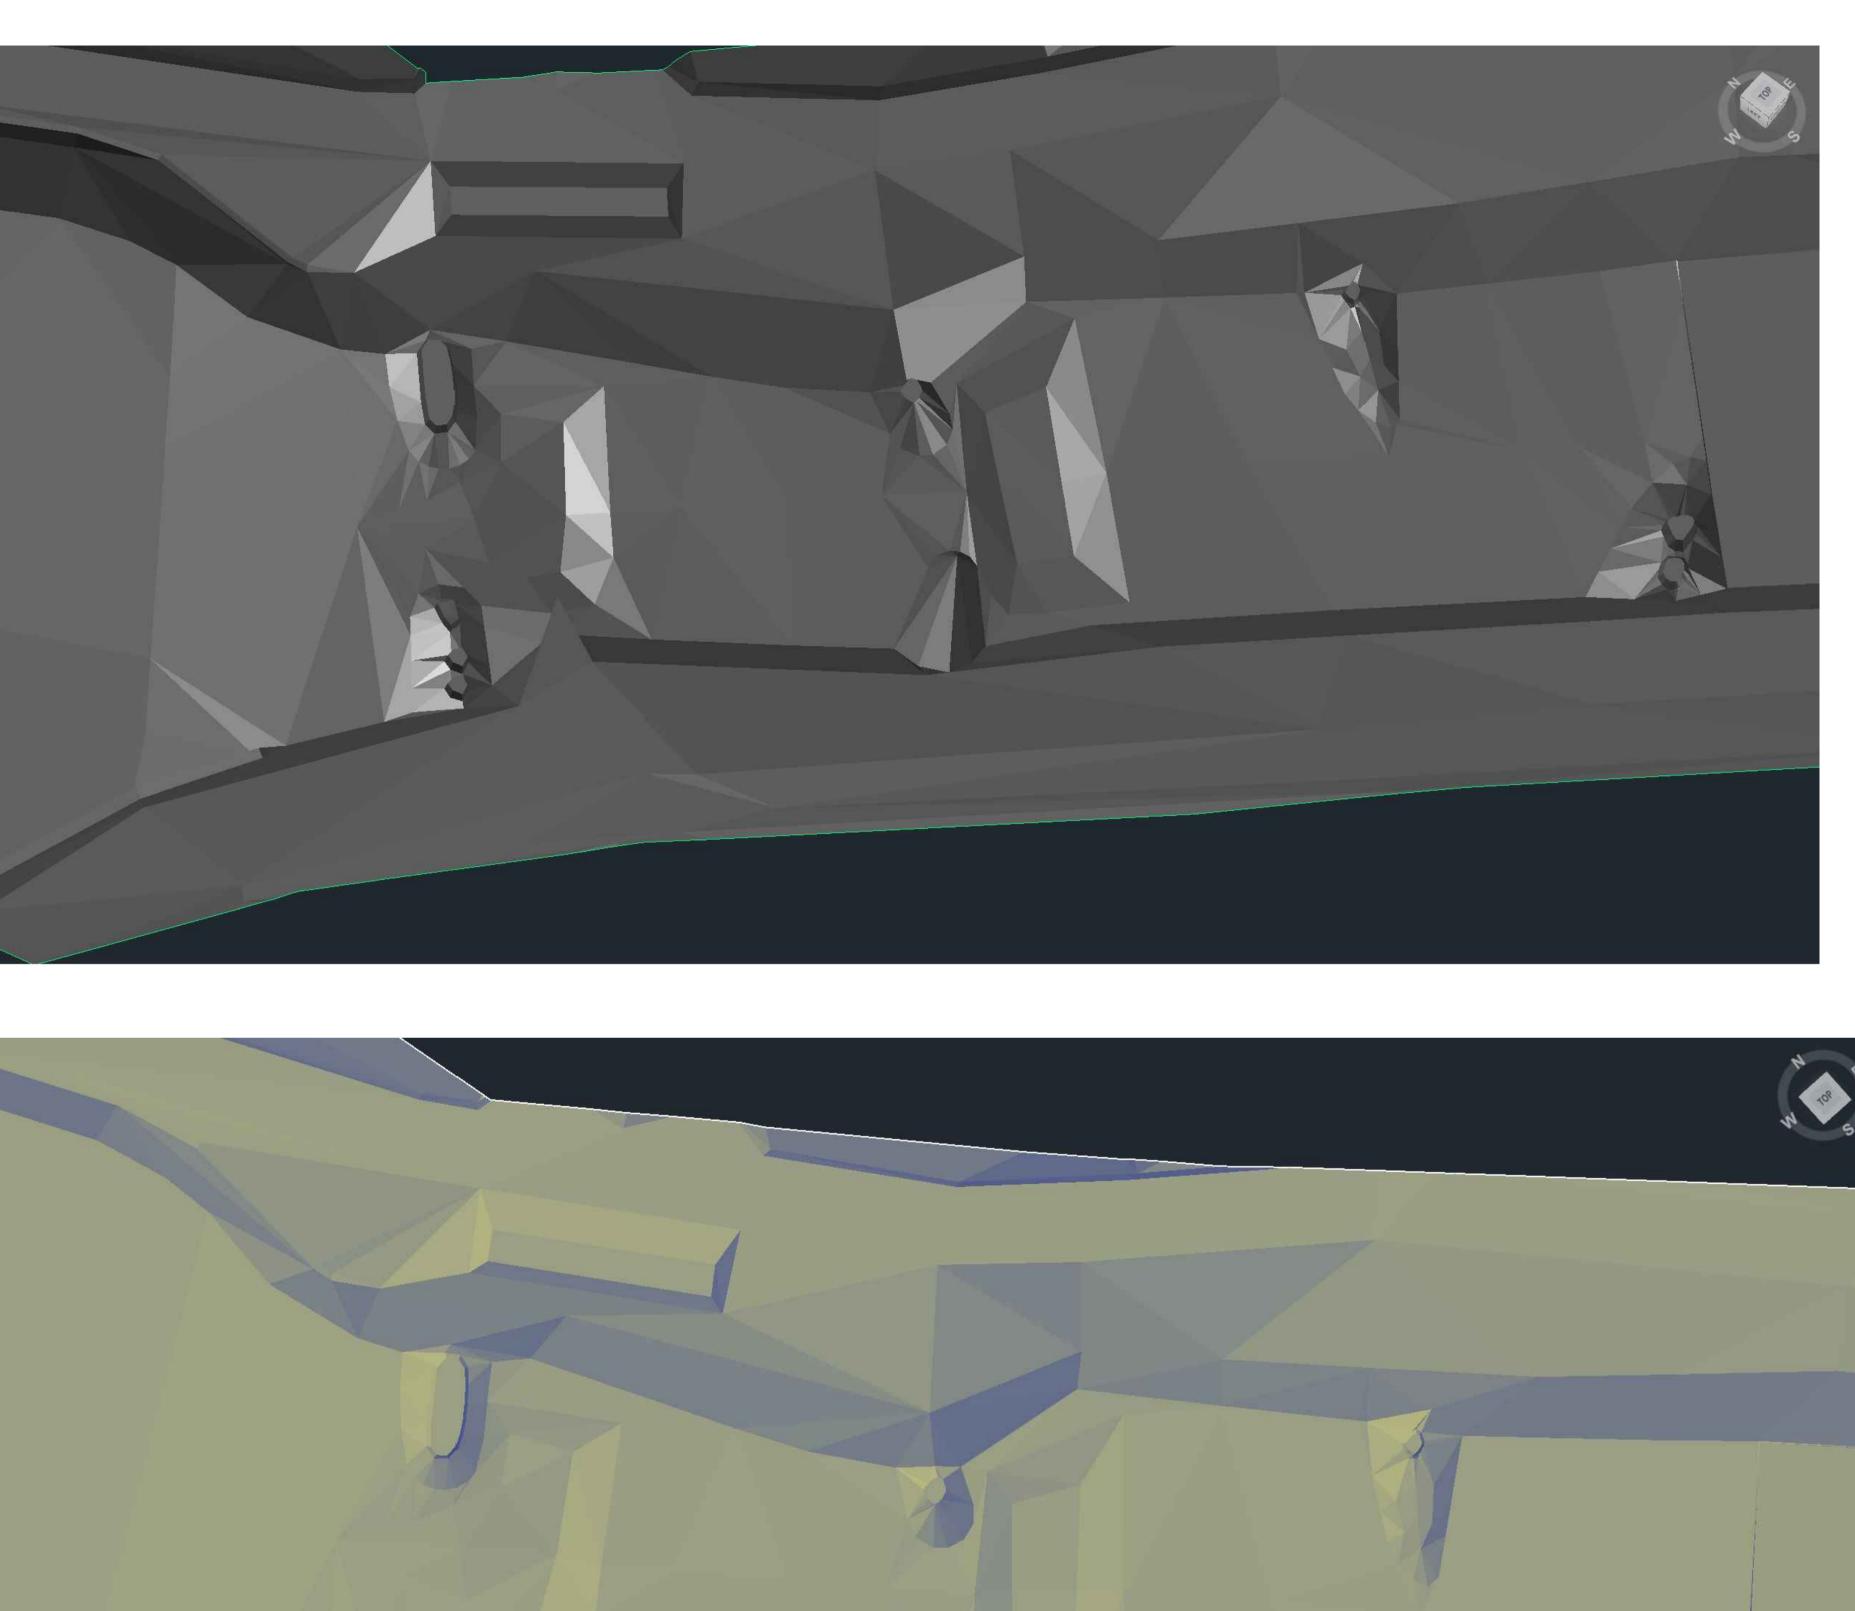
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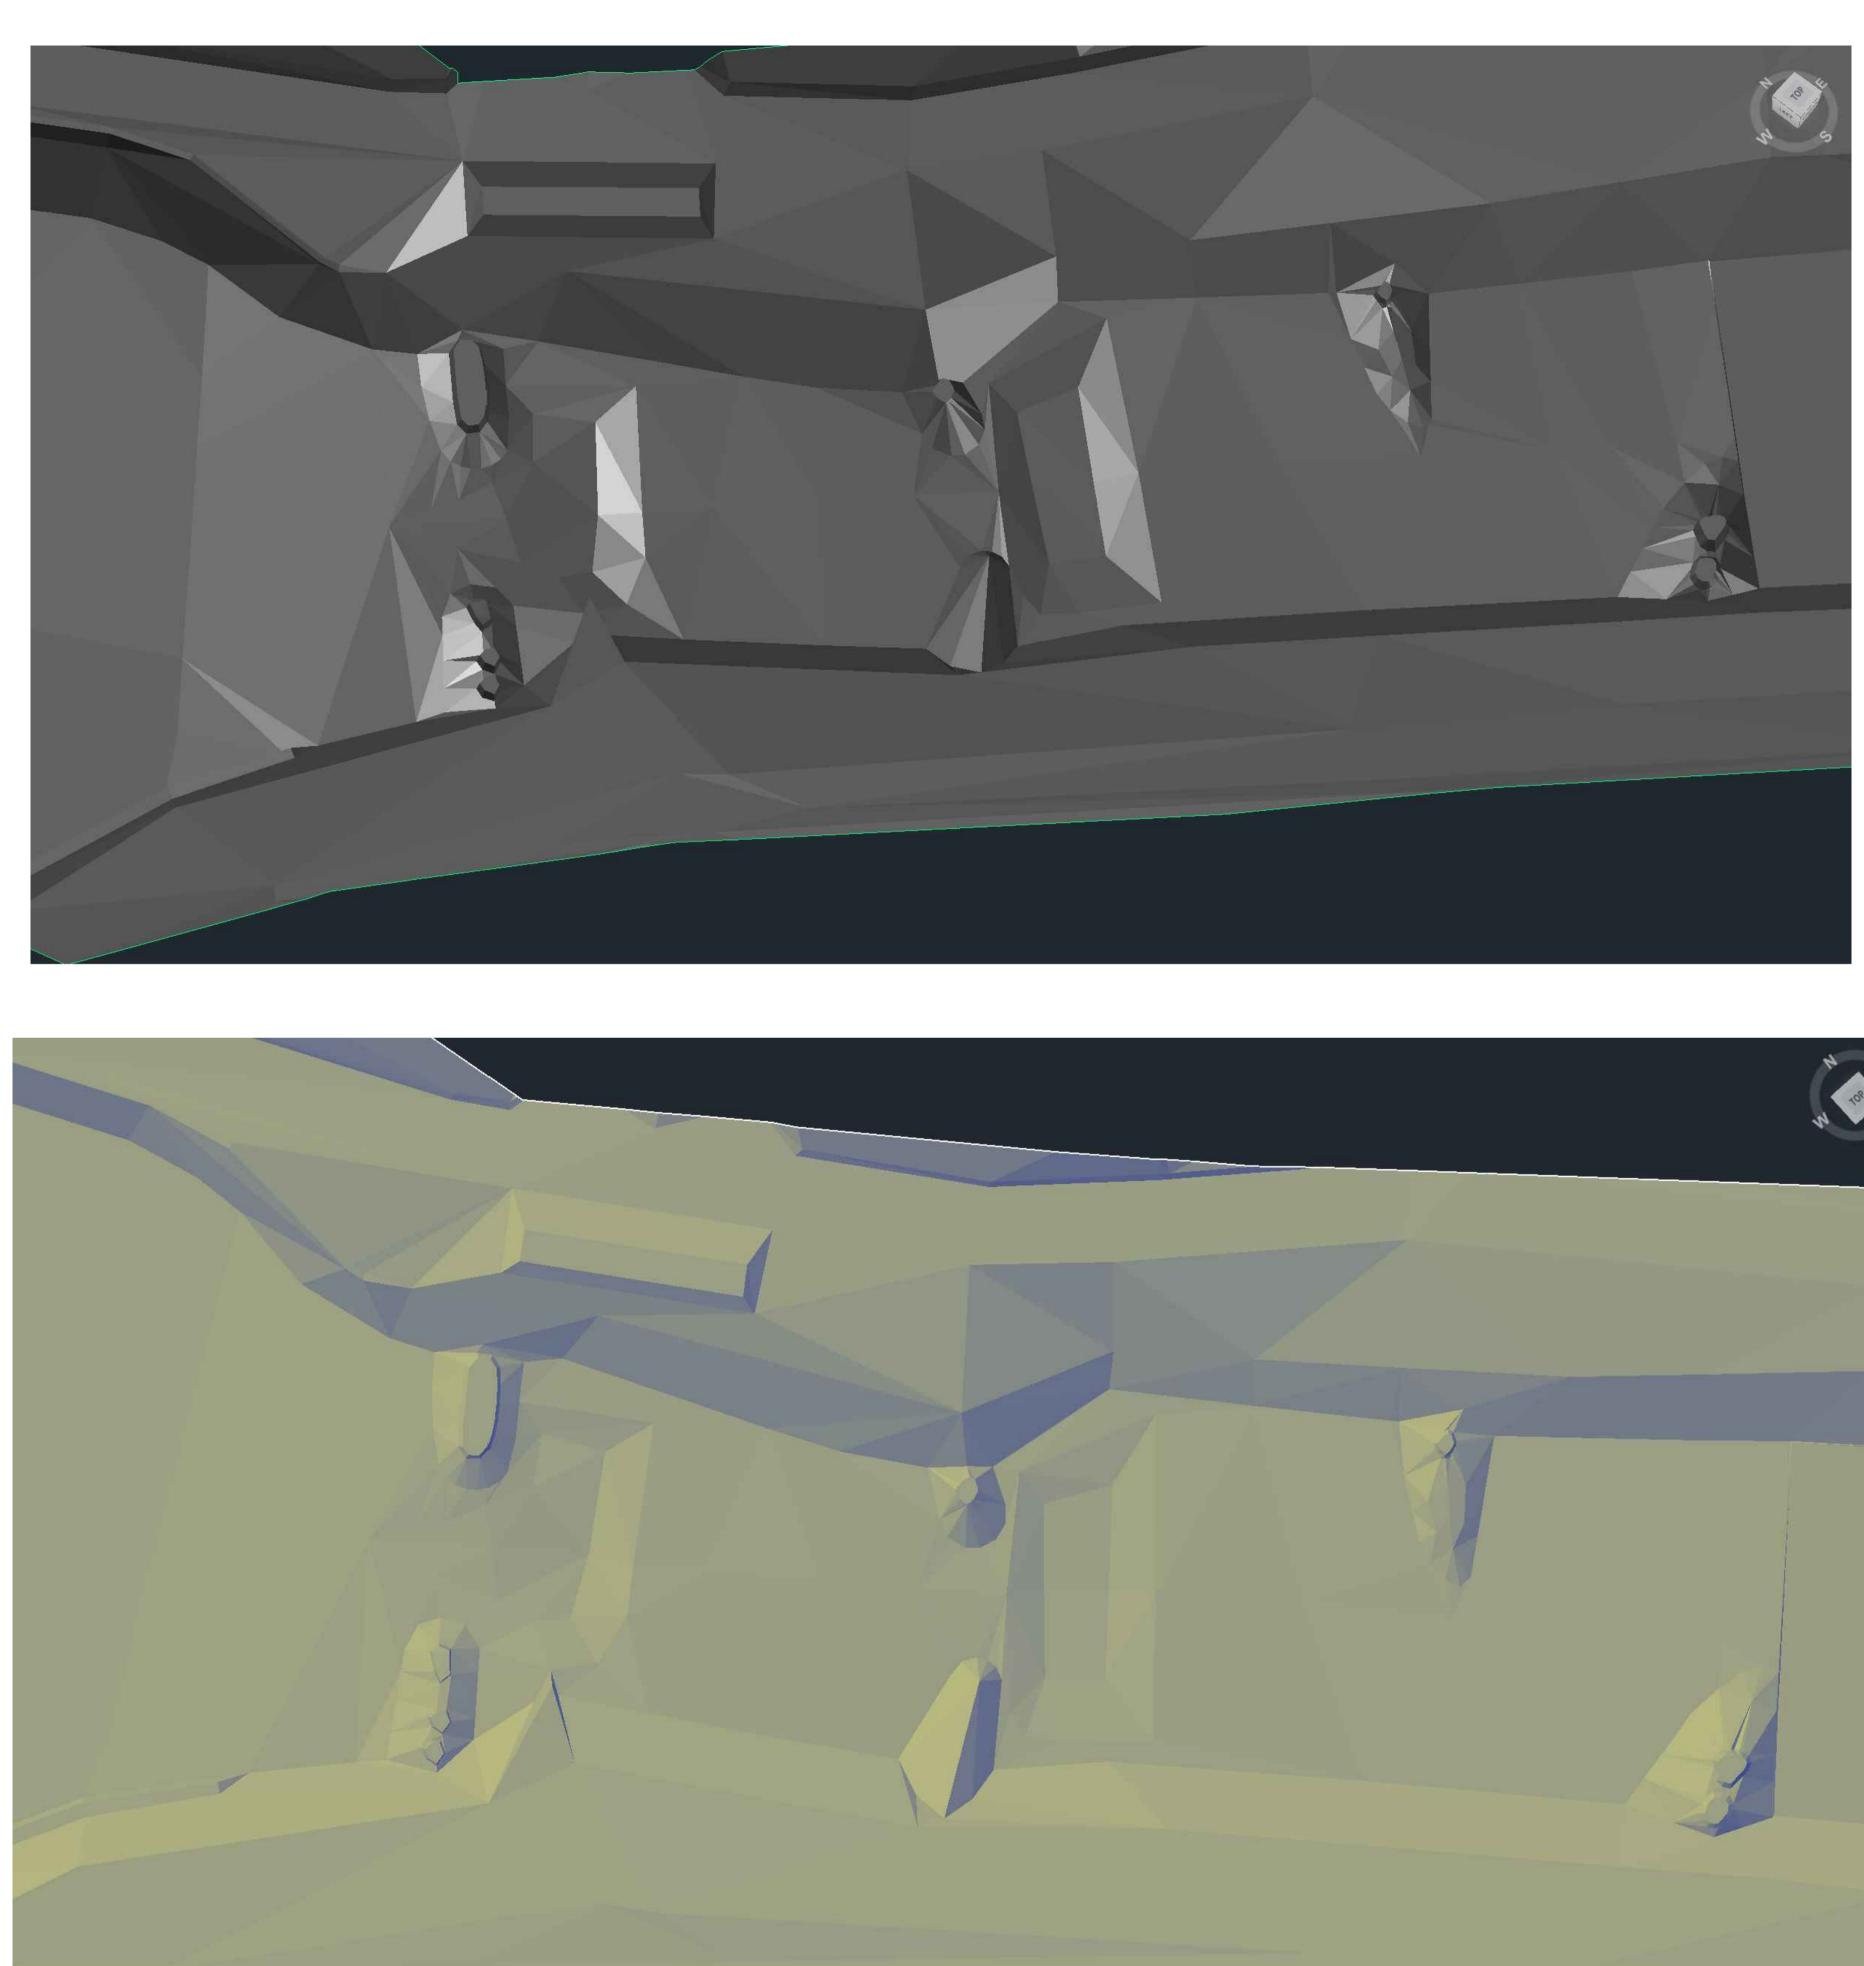
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WW-6.2







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Client: SLOVAK CANOEING

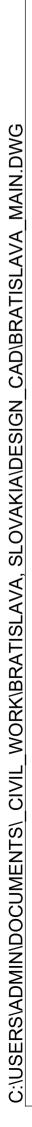Project Name: CUNOVO WATER SPORTS CENTRE RESTORATION

Status: 60% Design

Drawing Name: ISOMETRIC VIEW (4)

Revisions:

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Drawn By: Riley Adams, Danial Mason Checked By: Scott Shipley

Date: 03/05/2020

Coordinate System: JTSK

Vertical Datum: Bpv

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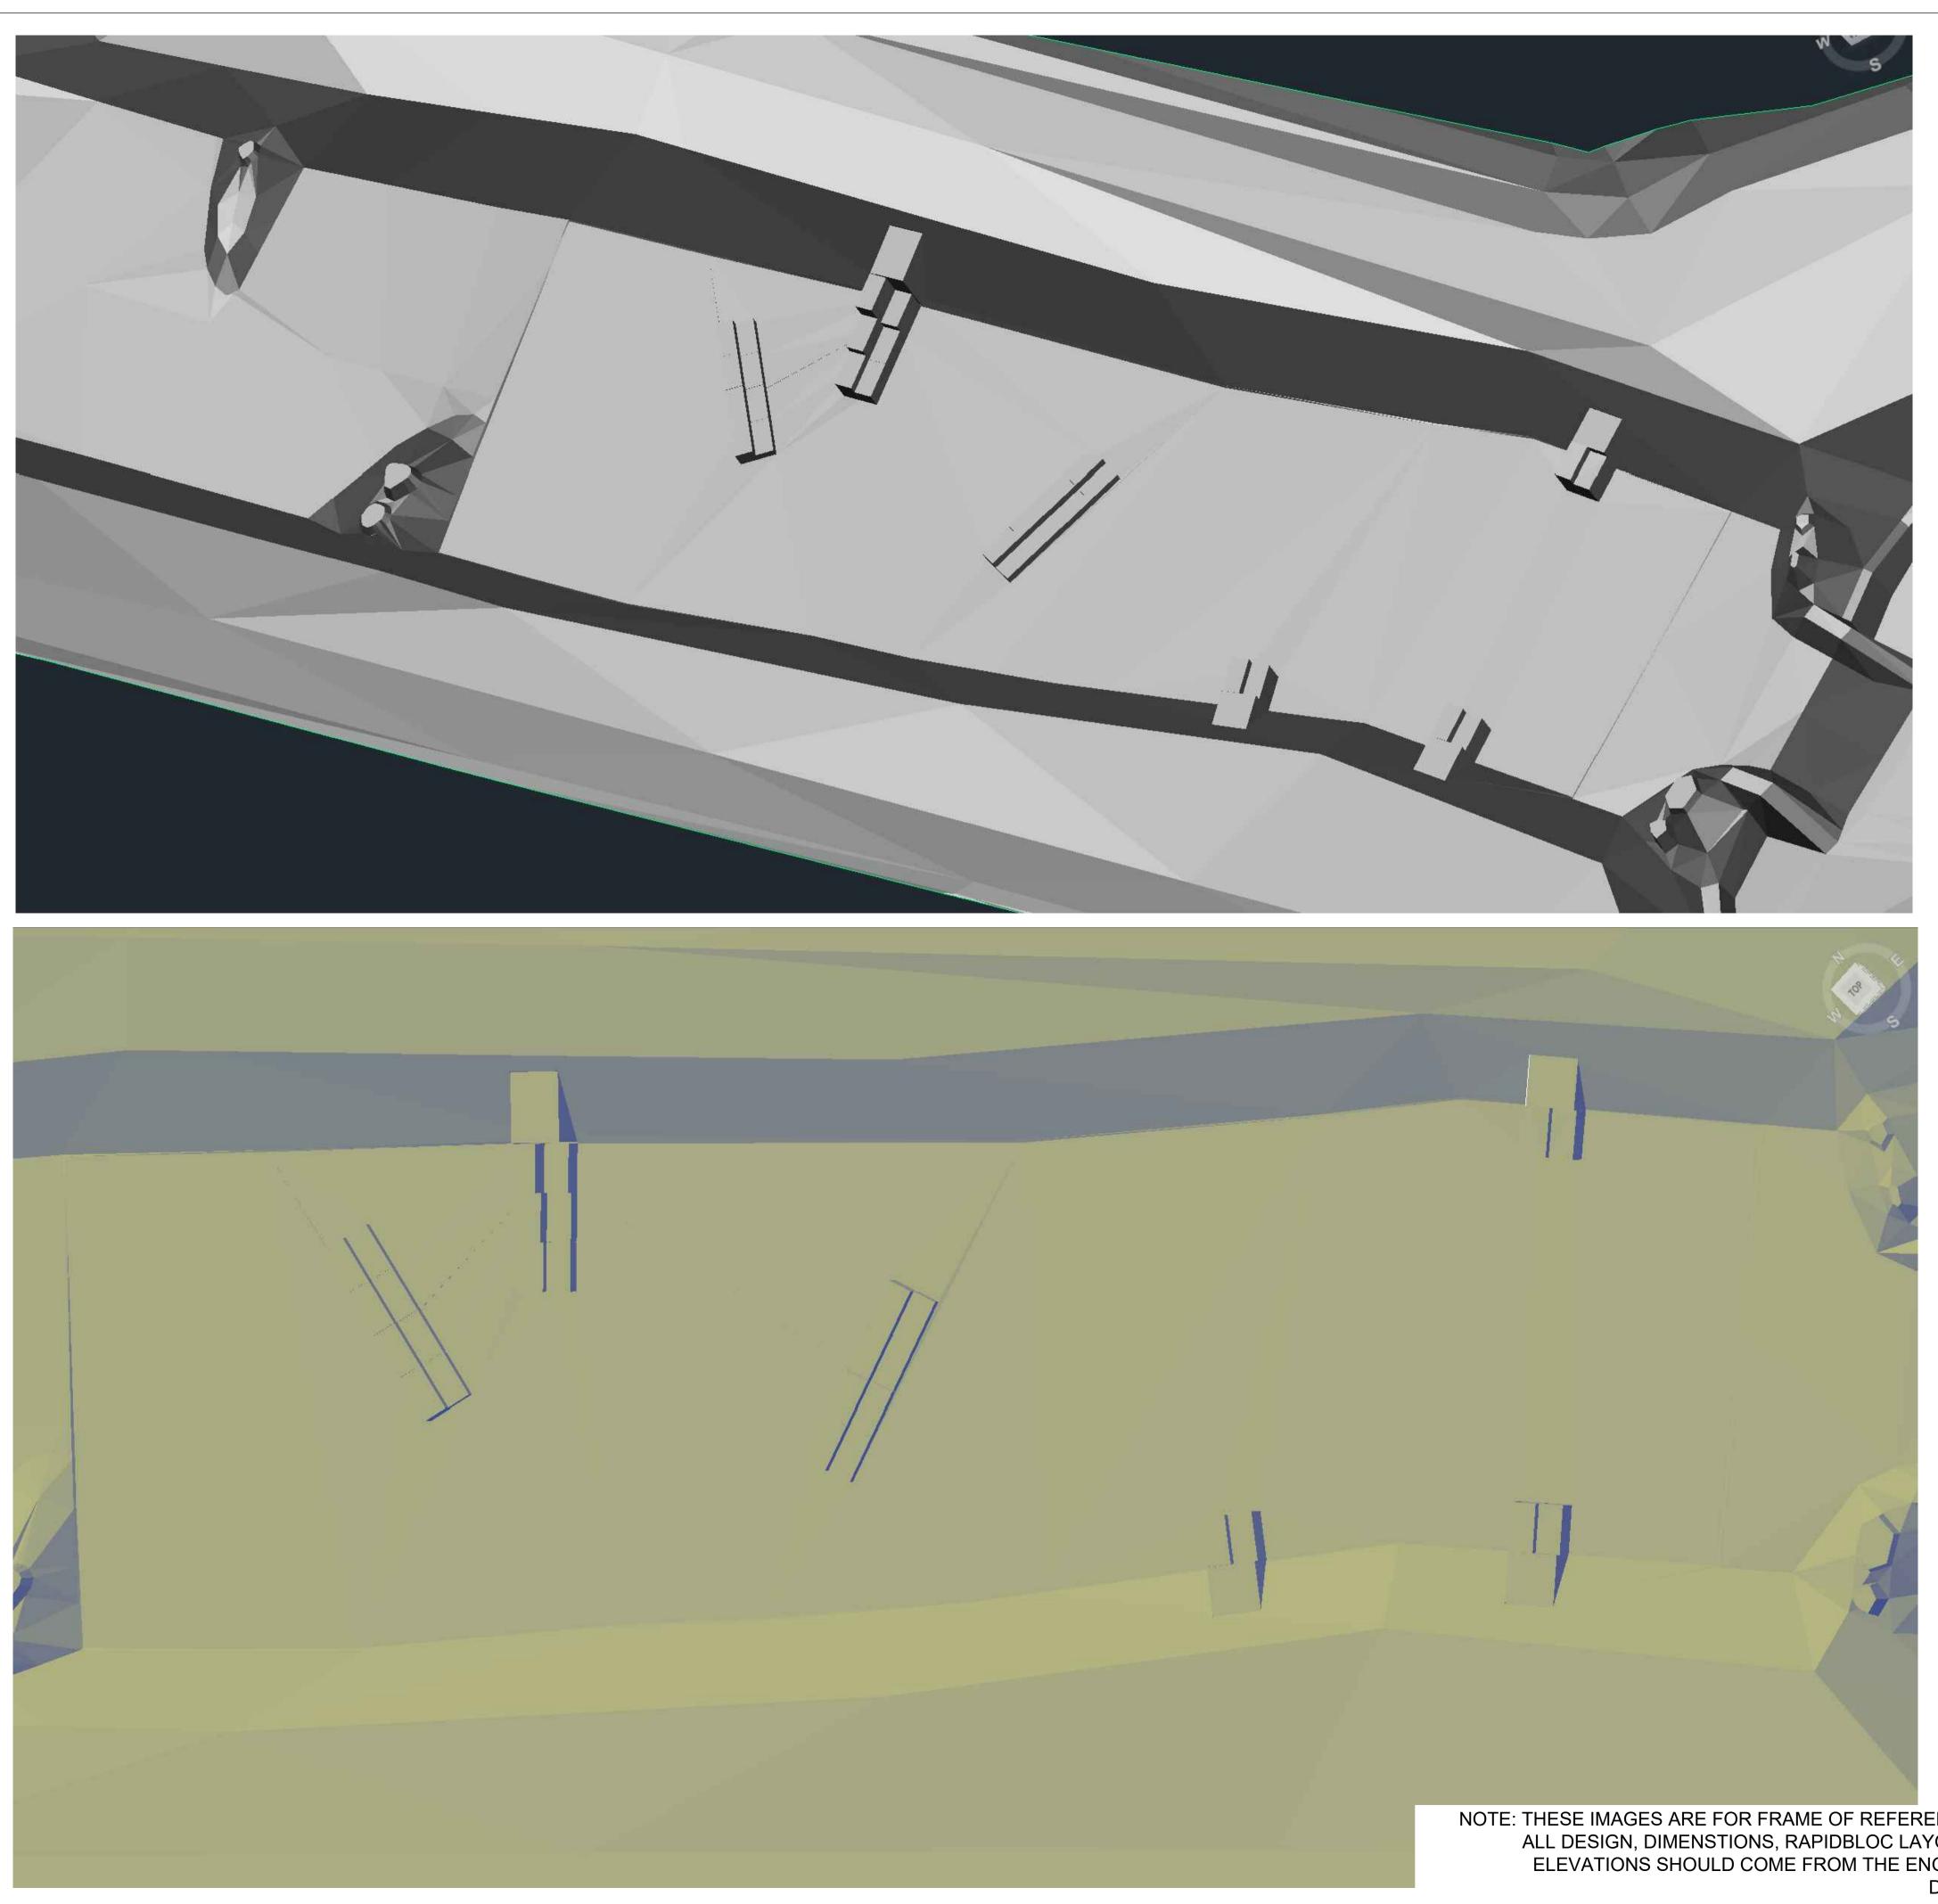
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Scale:

DRAWINGS.

Sheet:

WW-6.3



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FROM THE ENGINEERING
DRAWINGS.



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Client: SLOVAK CANOEING

Project Name: CUNOVO WATER SPORTS CENTRE RESTORATION

Status: 60% Design

Drawing Name: ISOMETRIC VIEW (5)

Revisions:

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Drawn By: Riley Adams, Danial Mason Checked By: Scott Shipley

Date: 03/05/2020

Coordinate System: JTSK

Vertical Datum: Bpv

Stamp


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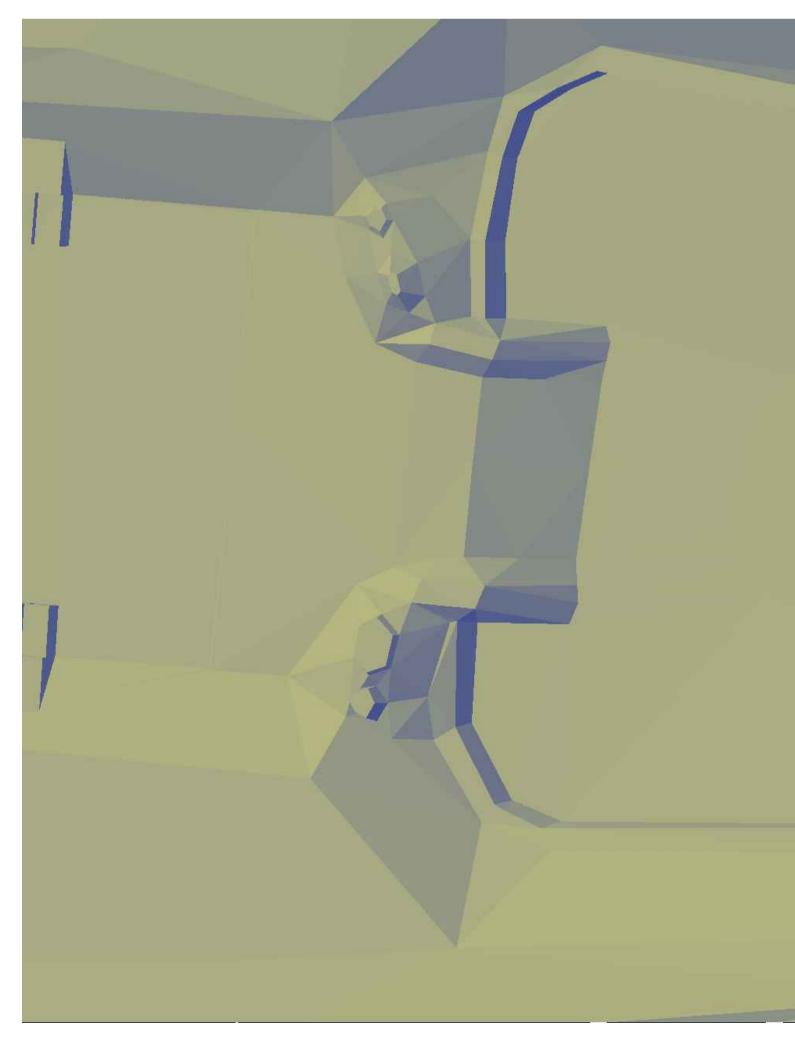
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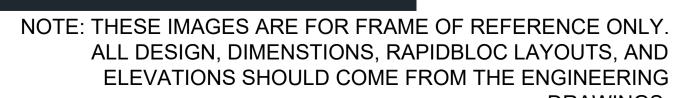
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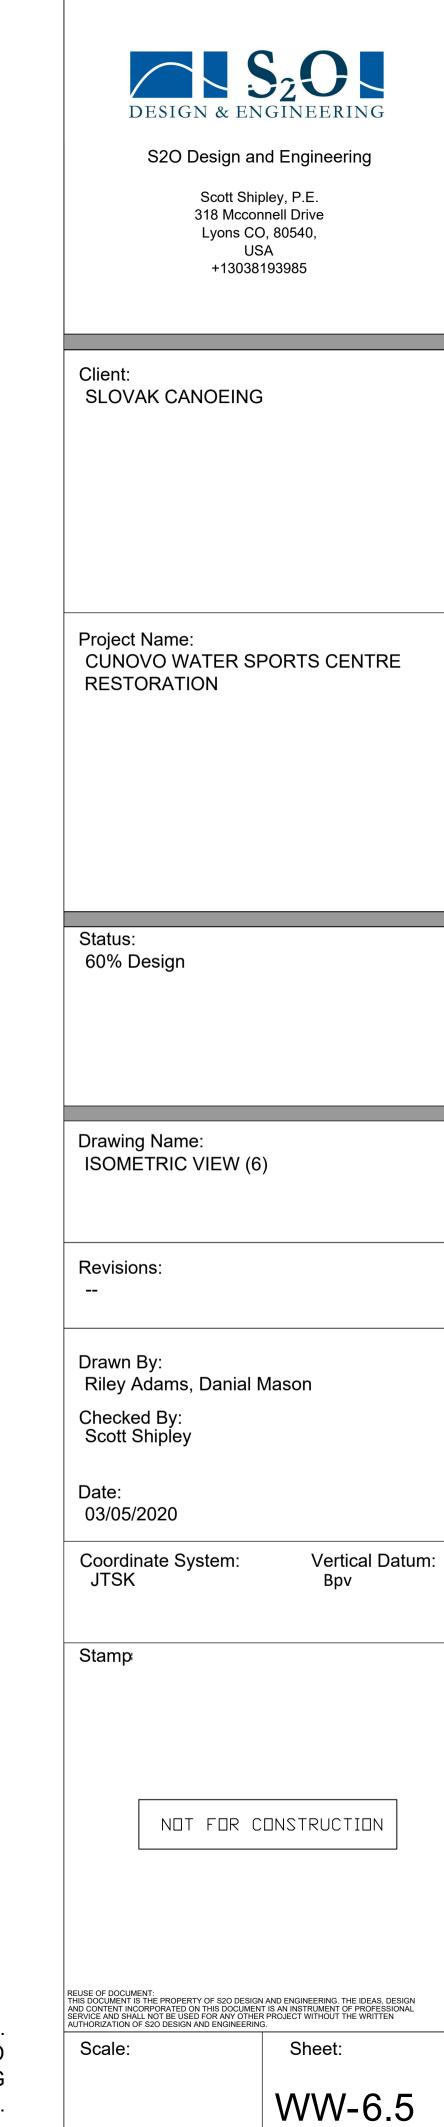
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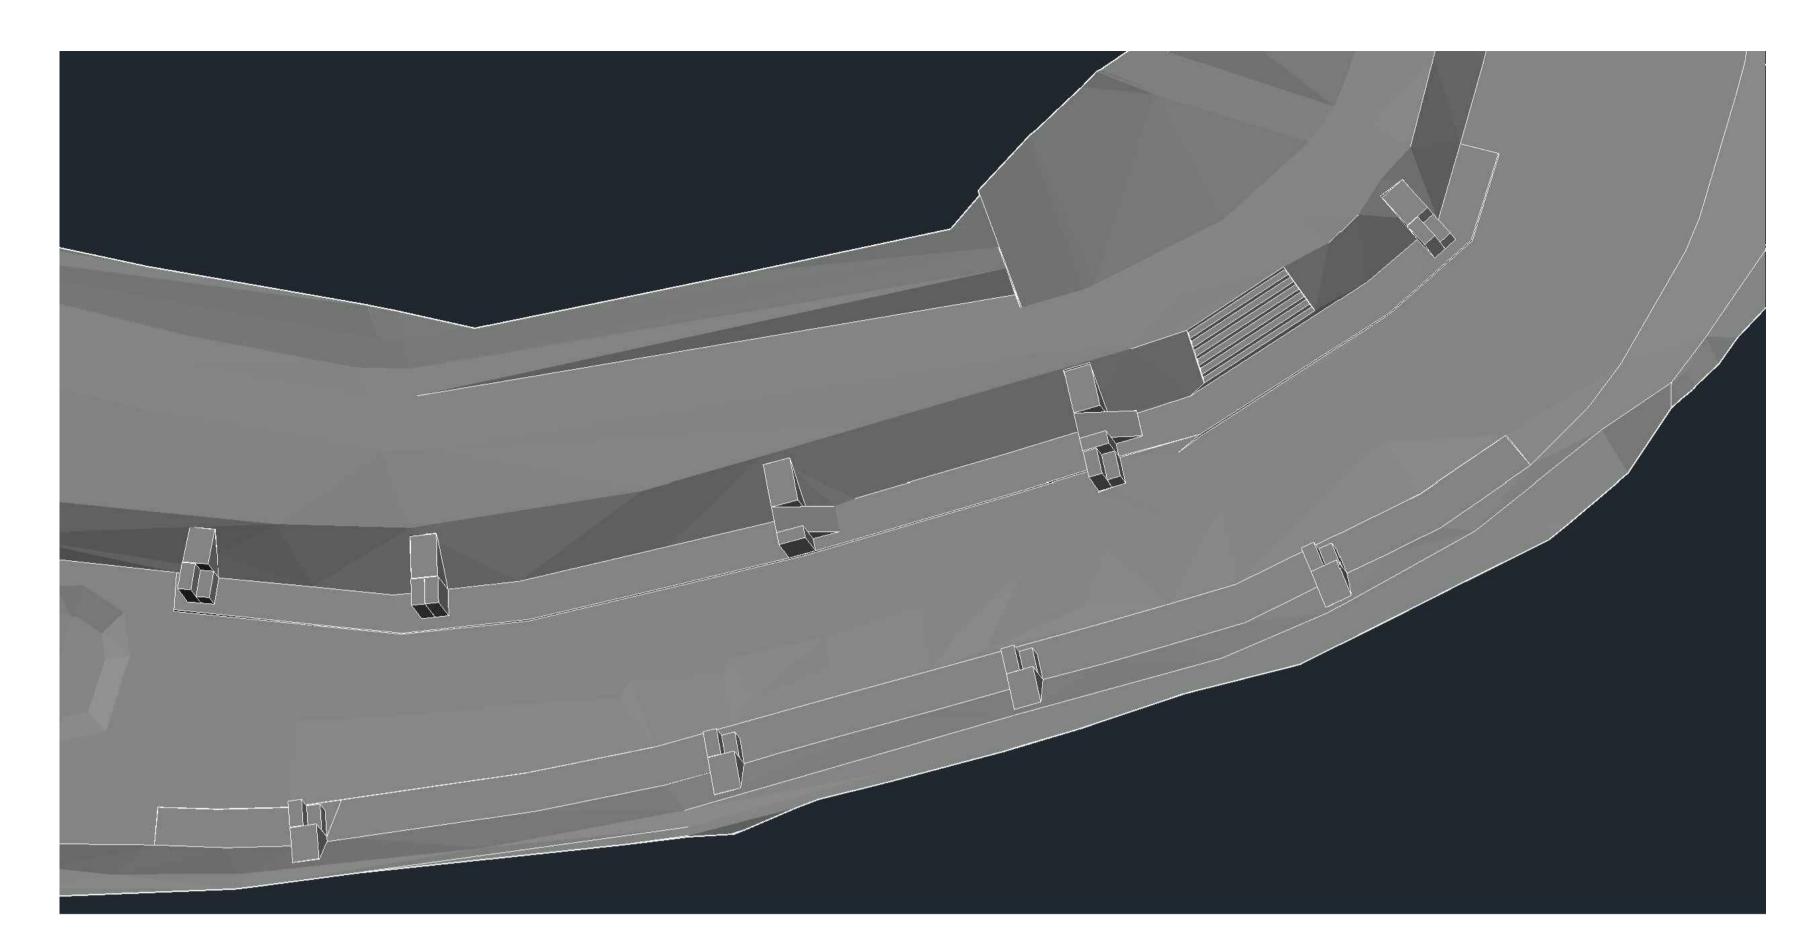










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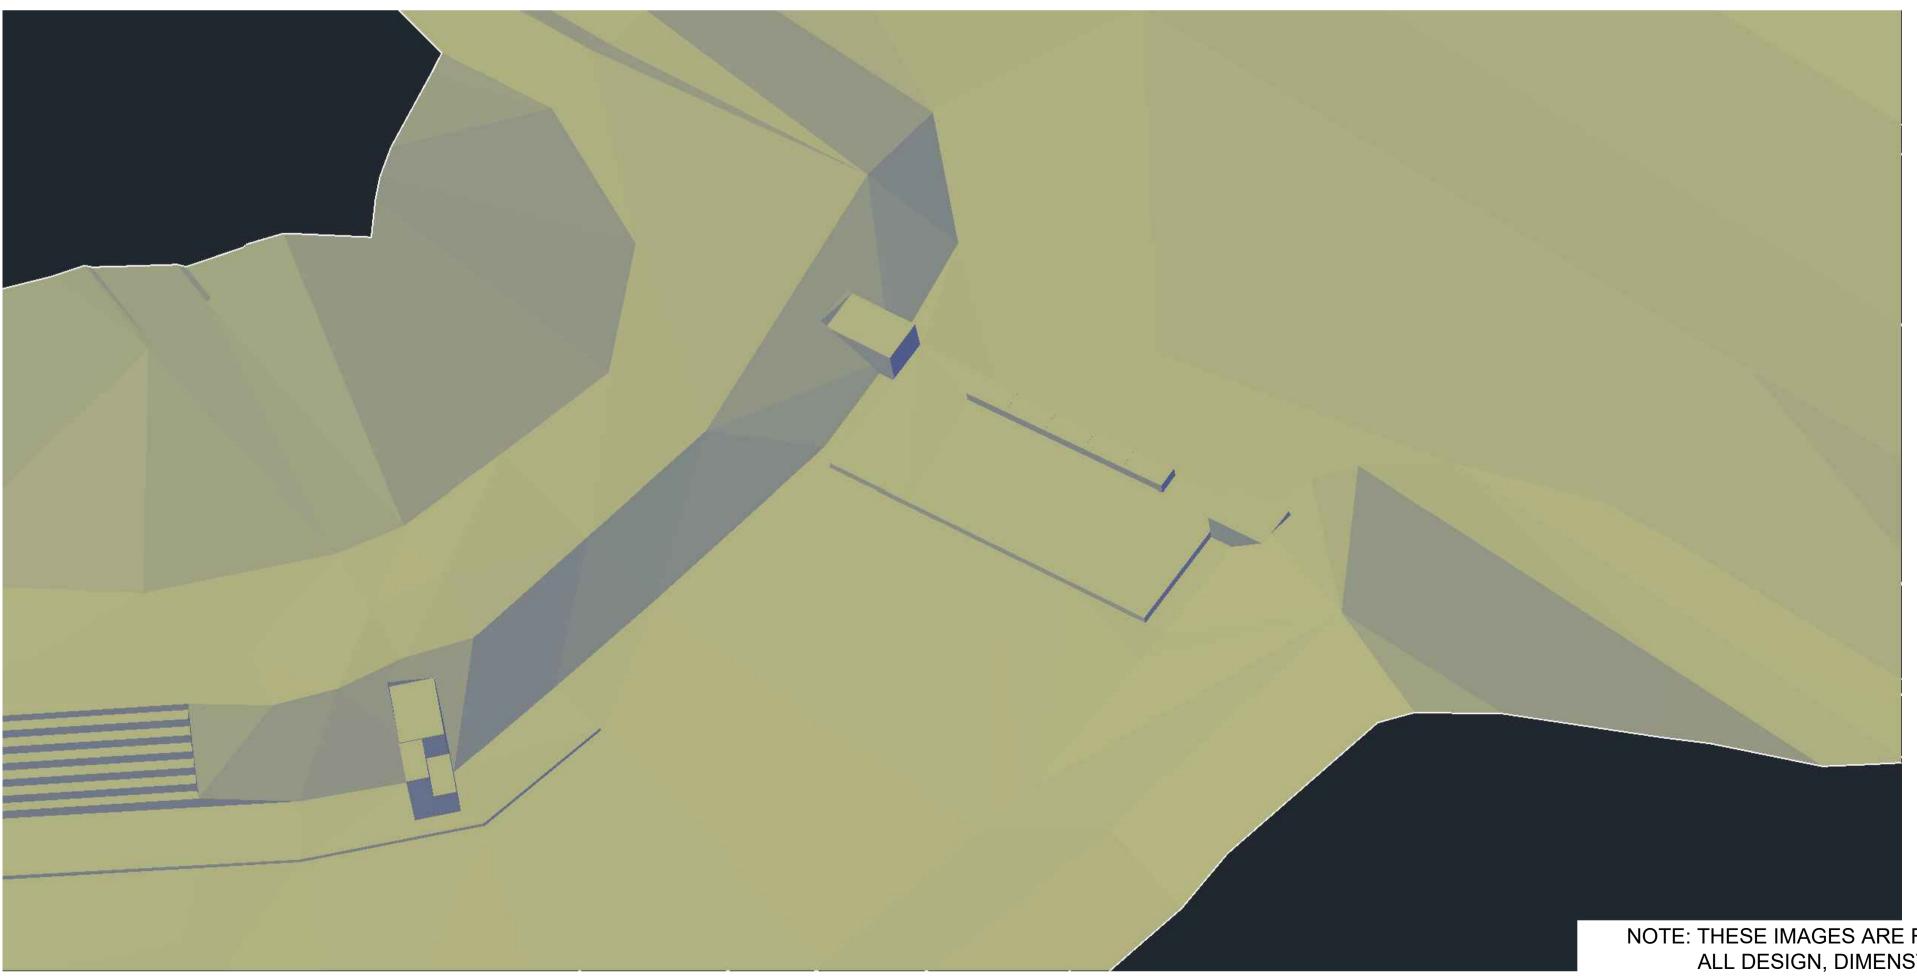


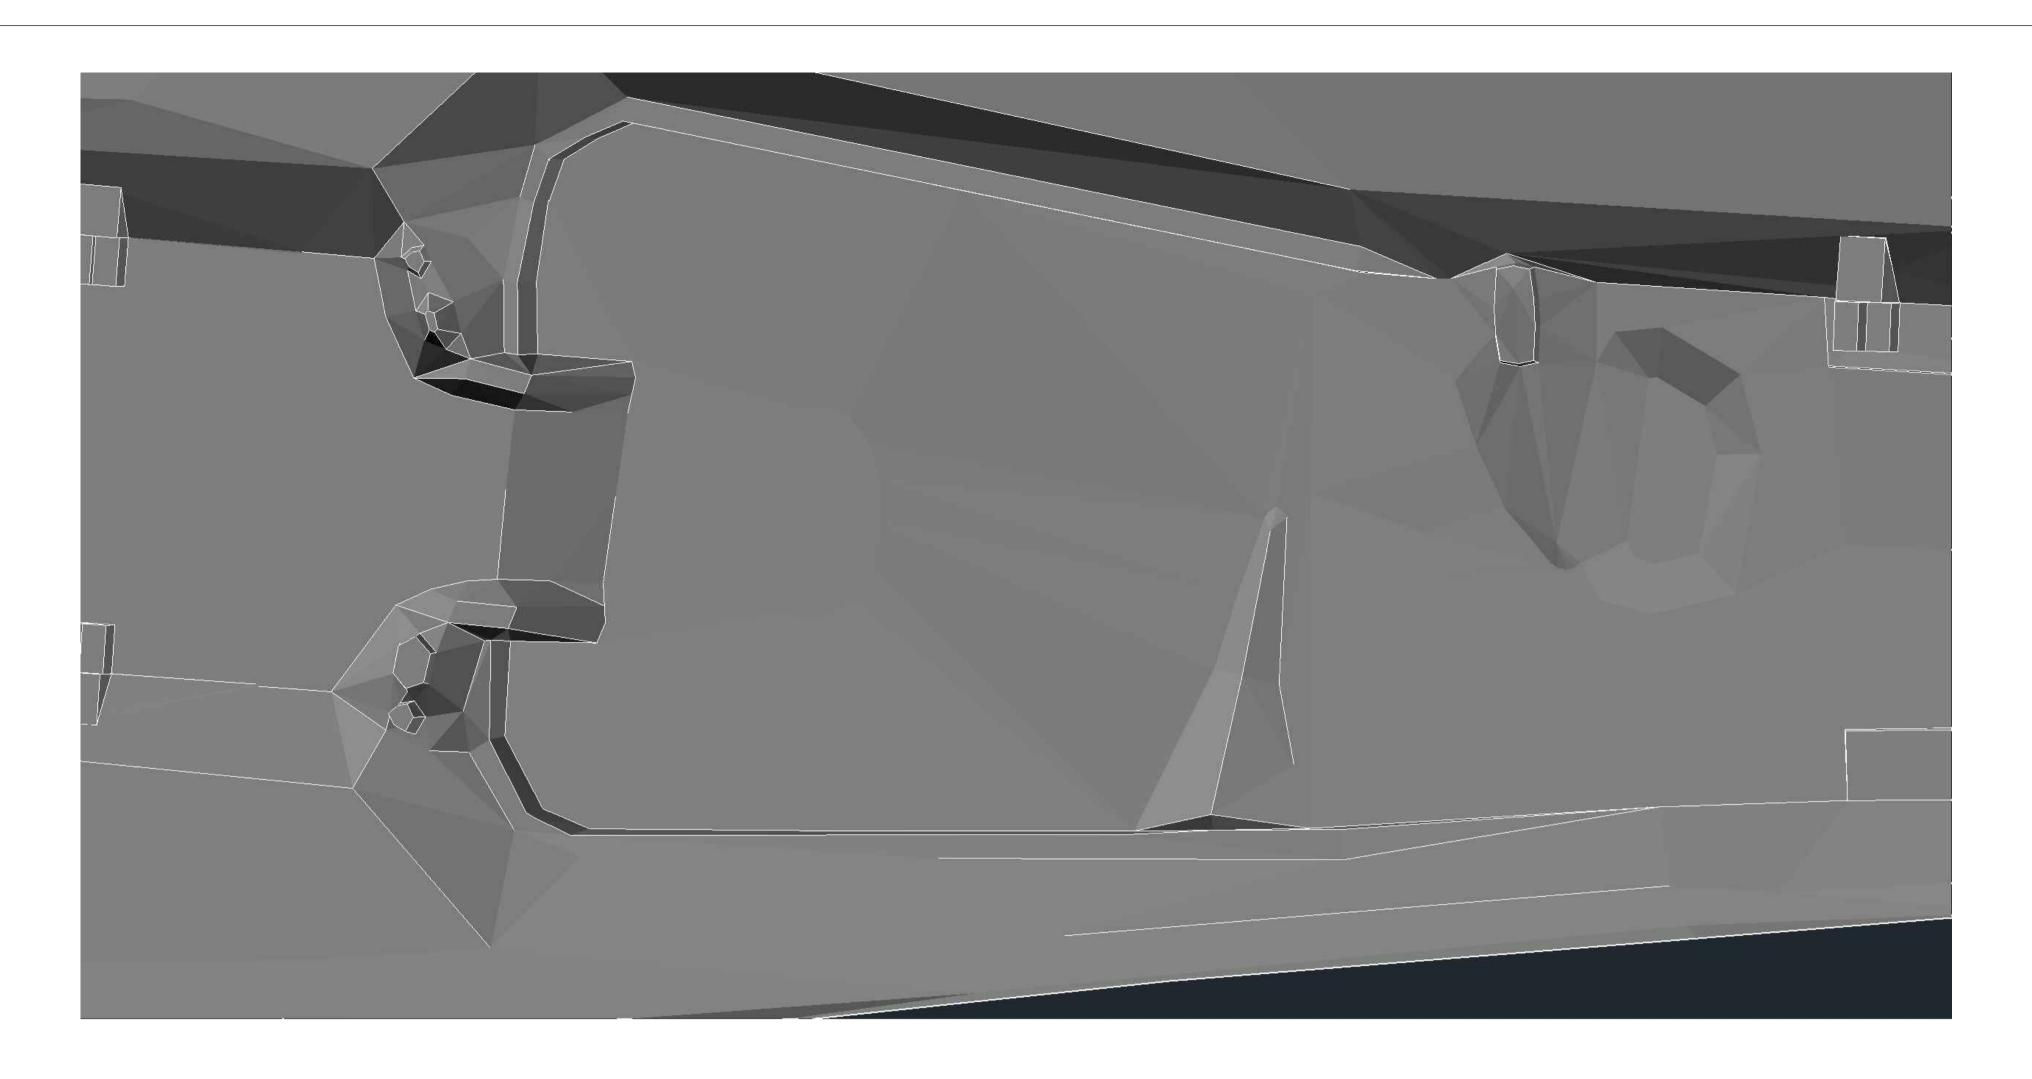
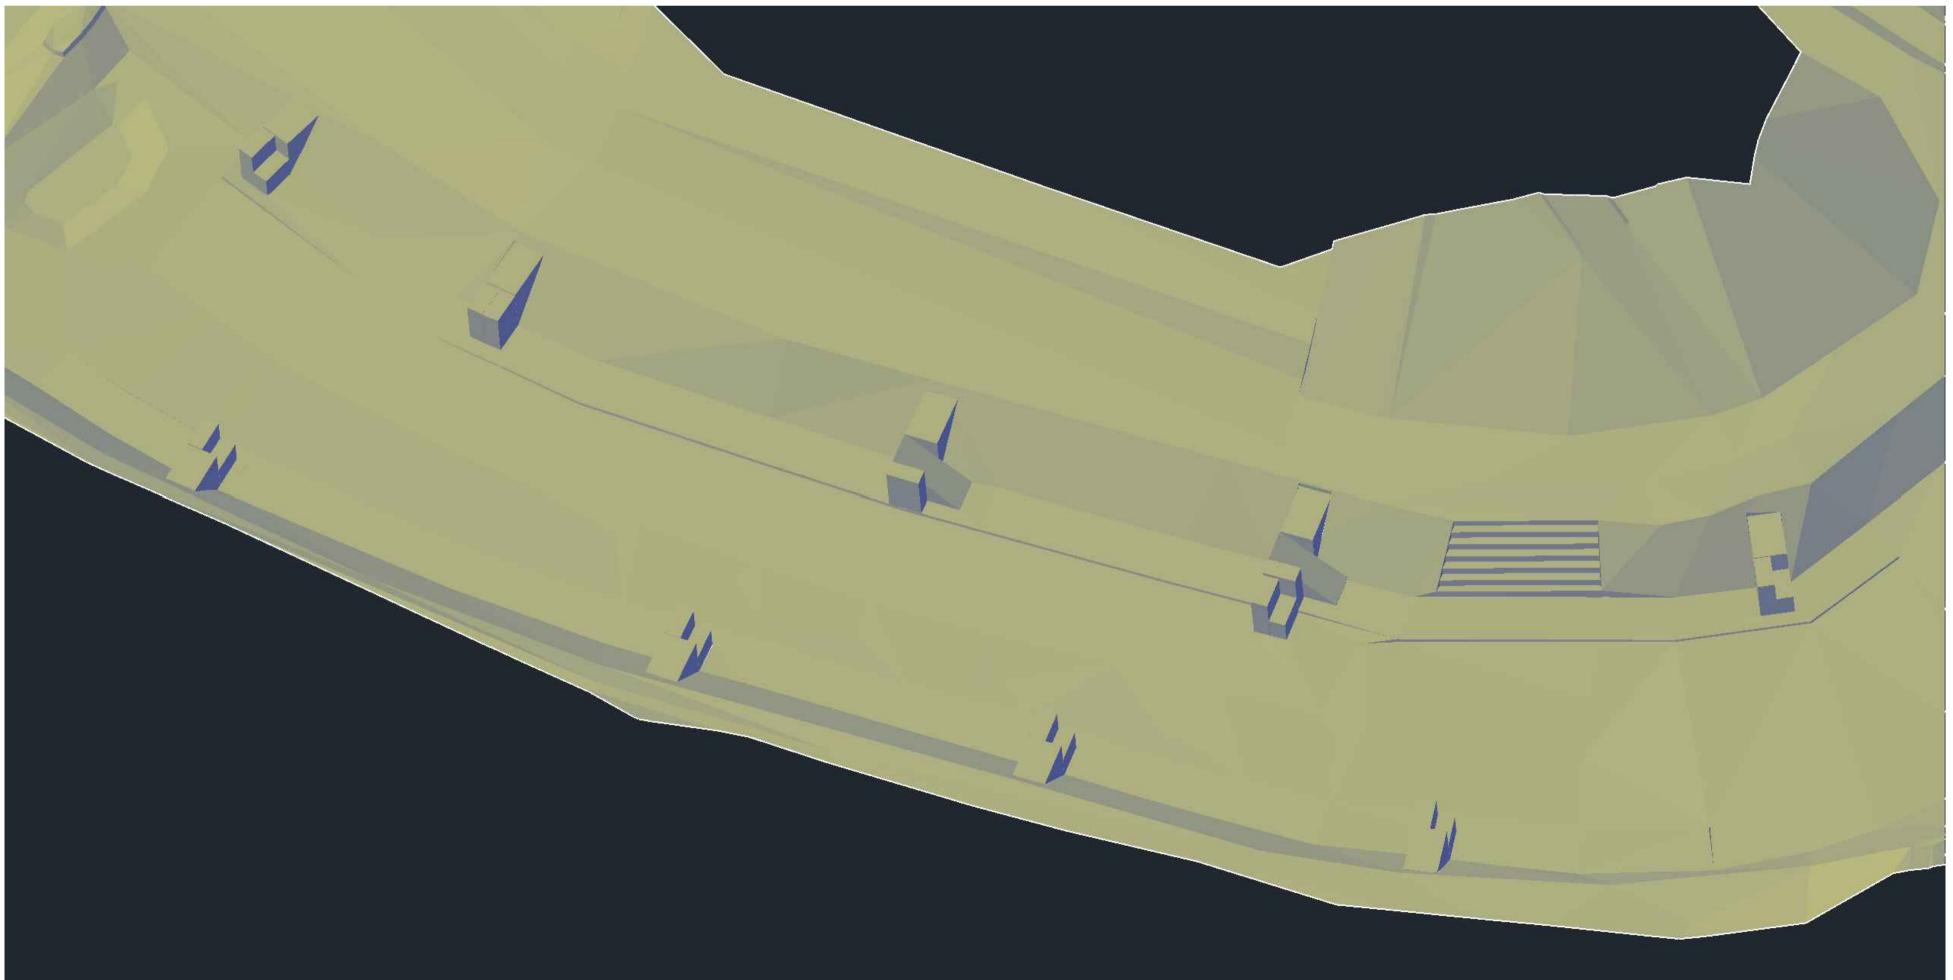
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Client: SLOV	Lyons CC US +13038	SA 193985
CÚNC	Name: NO WATER SF ORATION	PORTS CENTRE
Status: 60% [Design	
	g Name: ETRIC VIEW (7)
Revisio 	ons:	
Checke Scott	Adams, Danial N ed By: Shipley	Mason
03/05/ Coordi JTSK	nate System:	Vertical Datum: Bpv
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Project Name: CUNOVO WATER SPORTS CENTRE RESTORATION

Status: 60% Design

Drawing Name: ISOMETRIC VIEW (8)

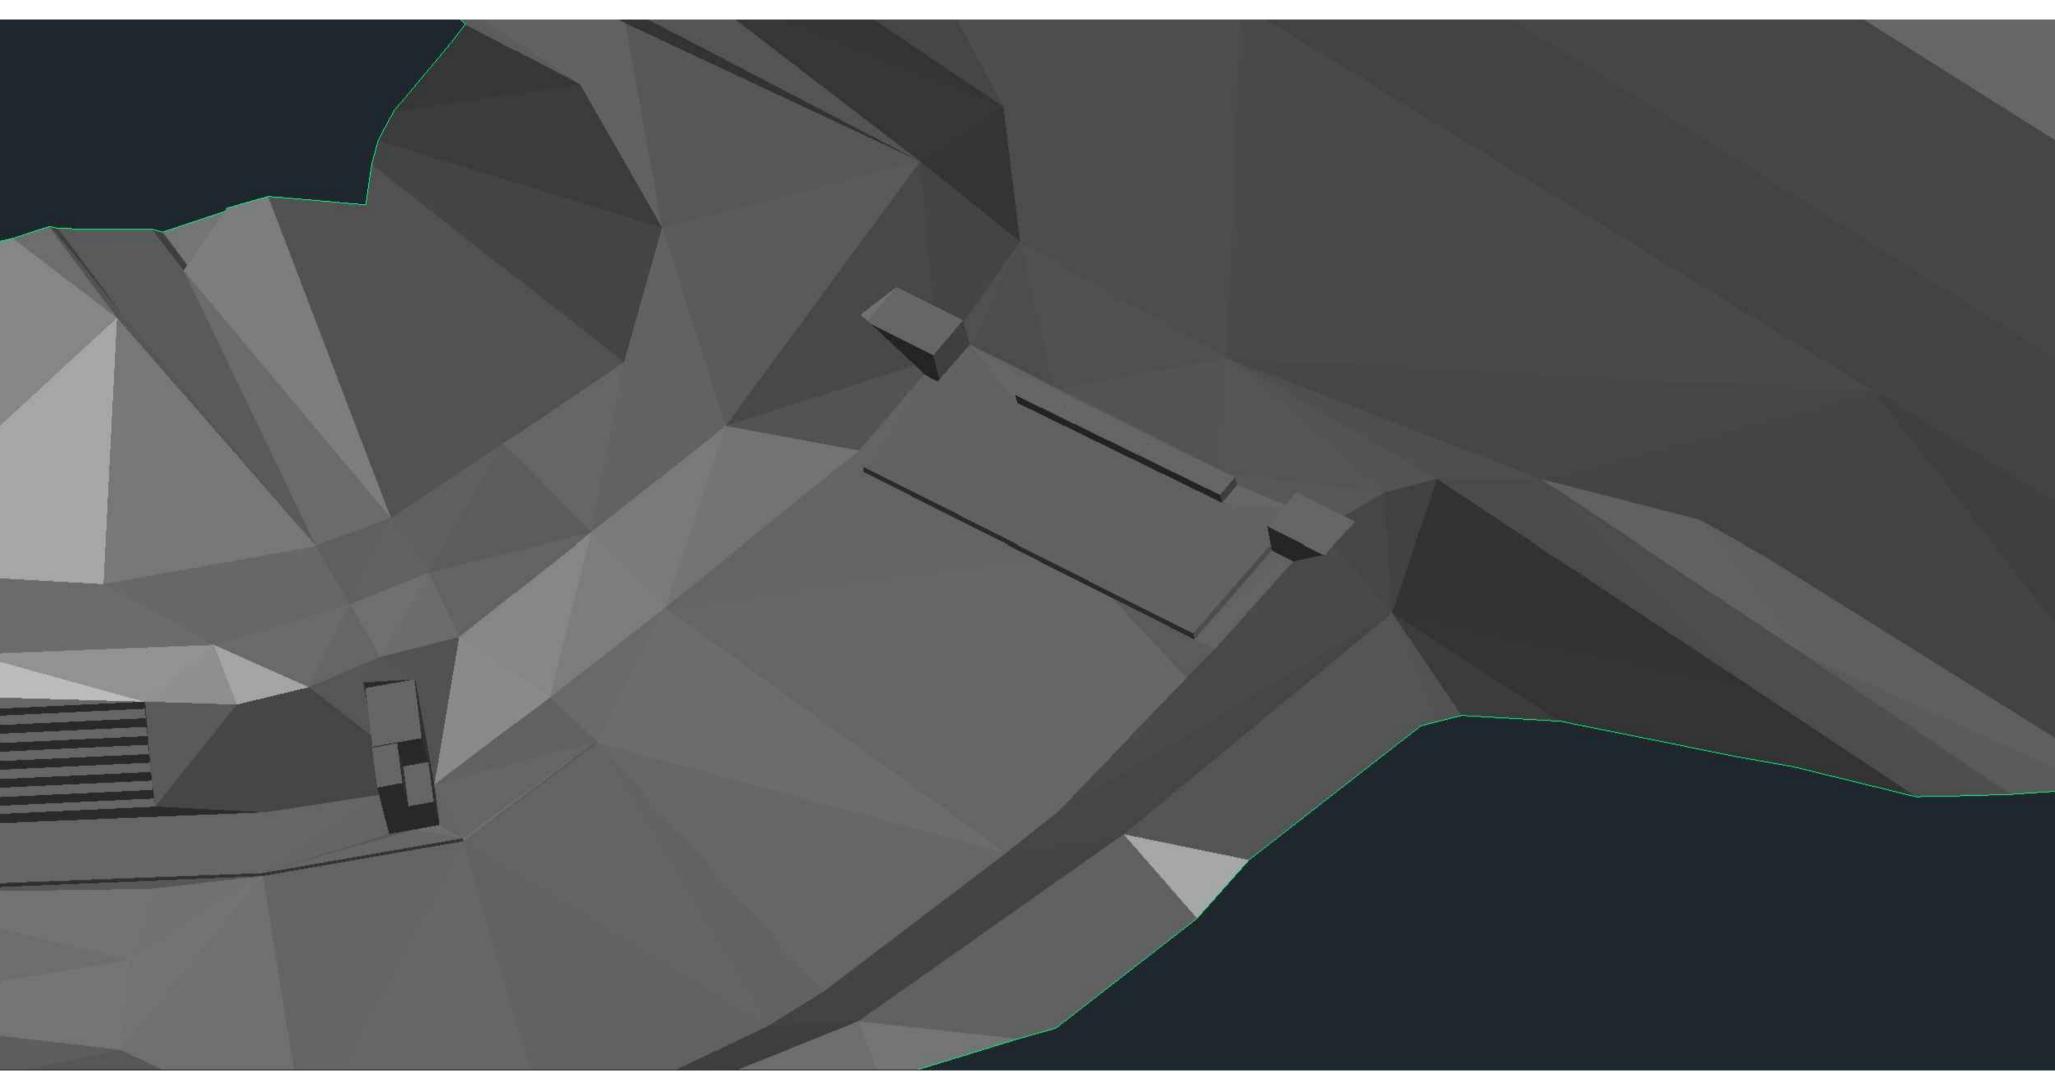Revisions:

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Drawn By: Riley Adams, Danial Mason Checked By: Scott Shipley

Date: 03/05/2020

Coordinate System: JTSK Vertical Datum: Bpv

Stamp

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